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Planning Commission Staff Report

TO: PLANNING COMMISSION / DESIGN REVIEW BOARD

FROM: JOSH ROGERS, PLANNER II

(480) 503-6589, JOSH.ROGERS@GILBERTAZ.GOV

THROUGH: CATHERINE LORBEER, AICP, PRINCIPAL PLANNER

(480) 503-6016, CATHERINE.LORBEER@GILBERTAZ.GOV

MEETING DATE: MAY 6, 2020

SUBJECT: DR19-143, BUNGALOWS ON ASH

STRATEGIC INITIATIVE: Prosperous Community

To allow a single-story multi-family development near the commercial environment along Gilbert Road.

RECOMMENDED MOTION

Approve the Findings of Fact and approve DR19-143 The Bungalows on Ash: Site plan, landscaping, grading and drainage, elevations, floor plans, lighting, and colors and materials for approximately 15.91 acres, generally located north of the northeast corner of Gilbert Rd. and Houston Ave., and zoned Multi-Family/Low (MF/L) with a Planned Area Development.

APPLICANT OWNER

Company: Pew & Lake Company: Gilbert Ash Development, LLC

Name: Sean B. Lake

Address: 1744 S. Val Vista Dr., Ste. 217 Address: 2157 E. Baseline Rd., Ste. 101

Mesa, AZ 85204 Tempe, AZ 85283

Phone: 480-461-4670

Email: sean.lake@pewandlake.com

BACKGROUND/DISCUSSION

History

Date	Description
June 17, 1986	Town Council adopted Ordinance No. 466 pertaining to rezoning approximately 31 acres to Planned Shopping Center-2 (PSC-2) for a retail and medical office center.
March 1, 1988	Town Council approved Z88-1 by adopting Ordinance No. 553, amending the original PAD and including the development plans for Price Savers.
April 13, 1995	Design Review Board approved site plan and elevations for a Kyoto Bowl restaurant.
July 21, 1998	Town Council approved SP444 pertaining to the Final Site Plan for Phase I, and preliminary site plan for phase II and III for a proposed shopping center on the subject parcel.
October 15, 1998	Design Review Board approved site plan and elevations for an IHOP restaurant.
April 11, 2000	Town Council approved Z99-53, amending the PAD to permit gas sales.
April 11, 2000	Design Review Board approved site plan and elevations for a QuikTrip gas station.
March 24, 2020	Town Council approved GP19-09 (Resolution No. 4124) and Z19-21 (Ordinance No. 2752) changing the land use designation and zoning district from General Commercial to Multi-Family/Low (MF/L) with a PAD.

Overview

The subject site is located between Baseline Road and Houston Ave. on the east side of Gilbert Road, directly north of the existing Sam's Club. The site was originally envisioned as part of the larger 31-acre shopping and medical center without any projects coming to fruition. The applicant is proposing 165 single-story for rent units on approximately 16 acres of land for an overall density of approximately 9.6 DU/Acre. The site is zoned Multi-Family/Low (MF/L) PAD.

Surrounding Land Use & Zoning Designations:

surrounding Land Use & Zoning Designations:				
	Existing Land Use	Existing Zoning	Existing Use	
	Classification			
North	Community Commercial	Community Commercial	Dignity Health Urgent	
		PAD	Care and undeveloped	
			building pad	
South	General Commercial	General Commercial	Sam's Club and other	
		PAD	retail establishments	
East	Residential > 5-8	Single Family – 7 (SF-7)	Sunview Public Park and	
	DU/Acre and Residential	and Single Family-	Sunview Estates	
	> 3.5-5 DU/Acre	Detached (SF-D)	Residential Community	

West	Residential >14-25	Single Family-6 (SF-6)	Gilbert Road and then
	DU/Acre and General	PAD and General Office	Gateway Court
	Office	(GO)	Residential Community
			and various professional
			offices.
Site	Residential 8-14 DU/Acre	Multi-Family/Low	Undeveloped
		(MF/L) PAD	

Project Data Table

Site Development Regulations	Bungalows on Ash PAD	
Maximum Building Height	26'/One-story	
(ft.)/(Stories)		
Minimum Building Setback (ft.)		
Front	25'	
Side (Non-residential)	20'	
Rear (Residential)	25'	
Separation Between Buildings (ft.)	10' *	
Minimum Required Perimeter		
Landscape Area (ft.)		
Front	20'	
Side (Non-residential)	15'	
Rear (Residential)	20'	
Common Open Space (Minimum)	43%	
Private Open Space (sq.ft.)	196 sq.ft./unit	

^{*} The development standards above shall govern, except that the building separation standard can be reduced by the building or fire code officials. Minor modifications to the configurations on the site plan shall be approved by the Planning Manager. All buildings shall comply with building codes and fire codes, which may result in a loss of units.

DISCUSSION

Site Plan

The Bungalows on Ash is a proposed gated multi-family community intended to feel like single family living. The proposed 165-unit community would be composed of a mixture of single story "single-family" attached and detached units, garage structures, parking canopy structures, 1 clubhouse/leasing office building with various outdoor amenities, a community swimming pool, a dog park, one (1) tot lot and various other outdoor turf areas. The residential units are designed in a cluster configuration, with typically 4-8 units clustered around a common connected pedestrian courtyard.

Access to the development will take place via one entrance off Gilbert Rd. and include a landscape median and design features that will create a prominent sense of arrival. A secondary exit only

access will be provided out to Gilbert Rd. at the northwest corner of the development. The main entrance will lead to a farmhouse style clubhouse that will also contain a leasing office. Branching off the main entry and parking lot are gated access points that connect to a looped system of private drives and parking areas for the residents.

All proposed parking will take place off the looped drive and contain individual parking stalls, enclosed garages and parking canopies. The parking lot will also include trash enclosures located in various areas close to the residents. Based on parking ratios for multi-family developments, the following table is representative of the Bungalows on Ash parking plan:

Bungalows on Ash Parking Counts		
	Required	Provided
1 space per 1-bedroom unit (40 units)	40	40
2 spaces per 2 or more bedroom units (125 units)	250	250
Resident Parking Total	290	290
	(124 covered)	(132 covered)
	(42 enclosed)	(42 enclosed)
Additional 25% of the total unit count for guest parking	42	47
Total Parking	332	337

Landscape

The project was granted a reduction of 2% to the minimum common open space requirement, from 45% to 43% (approx. 13,000 sq.ft. reduction) in their PAD. In exchange, the minimum private open space per unit was increased by approximately 136 sq.ft. for an estimated total increase of 22,500 sq.ft. private open space. The applicant notes the increased private open space is the result of the larger-than-required backyards for each unit.

The Bungalows on Ash integrates public, semi-private, and private open space components into a cohesive open space plan, with active and passive amenities through a centralized greenbelt extending from the main entrance through the community and to the public park on the eastern boundary. Pedestrian walkways have been placed throughout the community to interconnect the apartment homes to the broader community, including a lighted perimeter walking path for the enjoyment of residents.

Grading and Drainage

Runoff as required by the Town will be routed to underground ground storage locations throughout the development. The proposed grading and drainage plan generally meets the requirements of the Town of Gilbert's Engineering Division.

Elevations, Floor Plan, Colors and Materials

The Bungalows on Ash provides three architectural styles for the homes that are distinct from one another, presenting an appropriate amount of variety for this hybrid between multi-family and single-family homes. The proposed home elevations are variations of the farmhouse theme shown at the central clubhouse building and incorporate building materials such as stucco, concrete roof tiles, wood facia, hardie panel vertical siding, brick veneer, stone veneer and standing seam metal awnings. To create additional visual interest, the elevations also consist of shaker style shutters, board and batten shutters, wood facia, stucco pop outs, varying wall planes, recessed openings and building forms such as gable roofing. The combination of fenestration, proportions of building elements, exterior veneers, and variations in the roof line will break-up the vertical and horizontal planes for an enhanced appeal. The color scheme for the units consist of shades of white, tan, grey and varying shades of blue.

The front elevations of the homes will be the most visible as they will front onto the shared pathways and courtyards. The side and rear elevations will be screened by the backyard enclosures and hidden from view by the solid walls and landscaping. Interior spaces will include design features such as ten-foot high ceilings, larger scale windows, patios that transition to outdoor spaces, and private walled backyards for each unit that are approx. 196 sf.

The garage buildings follow the same basic architectural theme as the residential units and feature six garage bays with roll-up doors. The body of the buildings contain stucco, brick columns, hardie panel vertical siding and concrete roof tiles.

Lighting

Lighting consists of parking lot light poles, attached building wall mounted sconces, parking canopy lighting, and bollard lighting to illuminate the perimeter walking path. All site lighting will be required to comply with Town codes.

Signage

An 8' tall monument sign is proposed at the main site entrance and will be designed to complement the materials and colors of the buildings and site walls; however, other signage is not included in this approval. Staff has reviewed the conceptual design and location of the proposed monument sign. No further approvals of the monument sign other than permitting are needed.

PUBLIC NOTIFICATION AND INPUT

An official notice was posted in all the required public places within the Town and neighborhood notice was provided per the requirements of the Land Development Code (LDC) Article 5.205.

Staff has received no comment from the public for the Design Review. Staff did receive one comment from the public at the Town Council public hearing in opposition to the previous rezone/land use change.

STAFF RECOMMENDATION

Approve the Findings of Fact and approve DR19-143 The Bungalows on Ash: Site plan, landscaping, grading and drainage, elevations, floor plans, lighting, and colors and materials for

approximately 15.91 acres, generally located north of the northeast corner of Gilbert Rd. and Houston Ave., and zoned Multi-Family/Low (MF/L) with a Planned Area Development, subject to conditions:

- 1. Construction of the project shall conform to the exhibits approved by the Planning Commission at the May 6, 2020 public hearing.
- 2. The construction site plan documents shall incorporate the Standard Commercial and Industrial Site Plan Notes adopted by the Design Review Board on March 11, 2004.
- 3. Monument signage has been included in this approval and will require a sign permit prior to construction.

Respectfully submitted,

Josh Rogers Planner II

Attachments and Enclosures:

Joshua Rogers

- 1) Finding of Fact
- 2) Notice of Public Hearing
- 3) Aerial Photo
- 4) Site Plan
- 5) Landscape
- 6) Grading and Drainage
- 7) Colors and Materials
- 8) Elevations
- 9) Floor Plans
- 10) Lighting
- 11) Monument Signage

FINDINGS OF FACT DR19-143, Bungalows on Ash

- 1. The project as conditioned is consistent with the applicable Design Guidelines;
- 2. The project conforms to the General Plan, and specifically to the Land Use, Community Design, and Environmental Planning Elements;
- 3. The project is consistent with all applicable provisions of the Zoning Code;
- 4. The project is compatible with adjacent and nearby development; and
- 5. The project design provides for safe and efficient provisions of public services.

Notice of Public Hearing Attachment 2 - NOPH

PLANNING COMMISSION DATE:

Wednesday, May 6, 2020* TIME: 6:00 PM


LOCATION: Due to the impacts of the COVID-19 pandemic, all public meetings will be conducted using measures to protect public health until further notice. As a result, attendance in person by members of the public will be prohibited. Instead, the public can participate remotely through technological means, as permitted under Arizona law. Please refer to the meeting agenda for more details.

*Call Planning Division to verify date and time: (480) 503-6589

REQUESTED ACTION:

DR19-143 BUNGALOWS ON ASH: Site plan, landscaping, grading and drainage, elevations, floor plans, lighting, and colors and materials for approximately 15.91 acres, generally located north of the northeast corner of Gilbert Rd. and Houston Ave., and zoned Multi-Family/Low (MF/L).

SITE LOCATION:

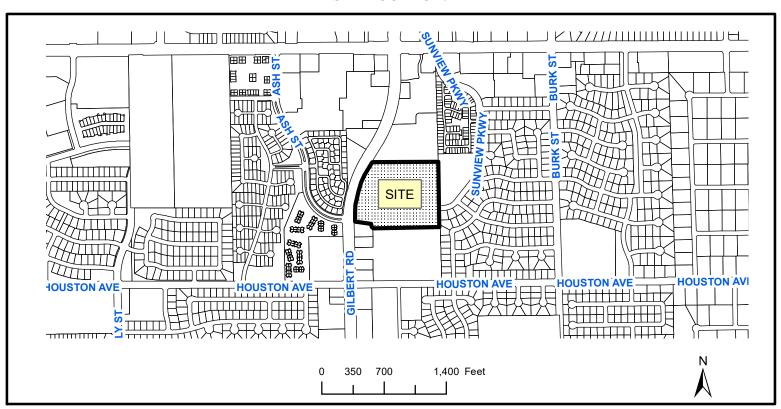

APPLICANT: Pew & Lake PLC

CONTACT:Sean Lake

ADDRESS: 1744 S. Val Vista Dr., Suite 217

Mesa, AZ 85204

TELEPHONE: (480) 461-4670 E-MAIL: sean.lake@pewandlake.com

^{*} The application is available to the public for review at the Town of Gilbert Planning Division Monday - Thursday 7AM - 6PM. Staff reports are available prior to the meeting at www.gilbertaz.gov/departments/development-services/planning/planning-commission and www.gilbertaz.gov/departments/development-services/planning/planning-commission and www.gilbertaz.gov/departments/development-services/planning/planning-commission and www.gilbertaz.gov/departments/development-services/planning/planning-commission and www.gilbertaz.gov/departments/development-services/planning-commission and www.gilbertaz.gov/departments/development-services/planning-commission and www.gilbertaz.gov/departments/development-services/planning-commission and www.gilbertaz.gov/departments/development-services/planning-commission and www.gilbertaz.gov/departments/development-services/planning-commission and <a href="https://www.gilbertaz.gov/departments/development-services/planning-commission-services/planning-commission-services/planning-services/planning-services/planning-services/planning-services/planning-services/planning-services/planning-services/planning-services/plann

DR19-143 Bungalows on Ash Attachment 3 - Aerial Map

Aerial Parcel Map

NEC Gilbert Rd. & Ash St. APN 304-10-021Y



BUNGALOWS ON ASH

DESIGN REVIEW - PRELIMINARY SITE PLAN

GILBERT, ARIZONA **CAVAN COMPANIES**

LEGAL DESCRIPTION

THAT PART OF THE SOUTH HALF OF THE WEST HALF OF THE NORTHWEST QUARTER OF SECTION 6, TOWNSHIP 1 SOUTH, RANGE 6 EAST OF THE GILA AND SALT RIVER BASE AND MERIDIAN, MARICOPA COUNTY, ARIZONA, ALSO KNOWN AS LOT 5, SECTION 6, TOWNSHIP 1 SOUTH, RANGE 6 EAST OF THE GILA AND SALT RIVER BASE AND MERDIANN, MARICOPA COUNTY, ARIZONA, DESCRIBED AS FOLLOWS: BEGINNING AT A POINT ON THE SOUTH LINE OF SAID WEST HALF OF THE NORTHWEST QUARTER OF SAID SECTION 6 FROM WHICH THE SOUTHWEST CORNER THEREOF BEARS NORTH 89 DEGREES 23 MINUTES 30 SECONDS WEST, 40.0 FEET; HENCE NORTH PARALLEL WITH THE WEST LINE OF SAID NORTHWEST QUARTER 639.01 FEET TO A POINT ON THE ARC OF A CIRCLE, THE CENTER OF WHICH BEARS EAST 1392.40 FEET; THENCE NORTHEASTERLY ALONG THE ARC OF SAID CIRCLE, 759.96 FEET; THENCE SOUTH 89 DEGREES 01 MINUTES 85 SECONDS EAST PARALLEL WITH THE NORTH LINE OF SAID NORTHWEST QUARTER, 787.52 FEET TO THE EAST LINE OF THE WEST HALF OF THE NORTHWEST QUARTER OF SAID SECTION 6; THE GILA AND SALT RIVER BASE AND MERIDIAN. MARICOPA COUNTY, ARIZONA, ALSO KNOWN AS LOT 5. SECTION 6. TOWNSHIP 1 SOUTH

THENCE SOUTH 0 DEGREES 20 MINUTES 11 SECONDS EAST ALONG THE EAST LINE OF SAID WEST HALF OF THE NORTHWEST QUARTER, 1359.96 FEET TO THE SOUTHEAST CORNER THEREOF:

THENCE NORTH 89 DEGREES 23 MINUTES 30 SECONDS WEST ALONG THE SOUTH LINE OF SAID WEST HALF OF THE NORTHWEST QUARTER 997.74 FEET TO THE TRUE POINT OF BEGINNING:

997.74 FEET TO THE TRUE POINT OF BEGINNING;
EXCEPT THE FOLLOWING PROPERTY:
THAT PART OF LOT 5, SECTION 6, TOWNSHIP 1 SOUTH, RANGE 6 EAST OF THE GILA AND SALT RIVER BASE AND MERIDIAN, MARICOPA
COUNTY, ARIZONA, DESCRIBED AS FOLLOWS:
BEGINNING AT A POINT ON THE SOUTH LINE OF THE WEST HALF OF THE NORTHWEST QUARTER OF SAID SECTION 6 FROM WHICH THE
SOUTHWEST CORNER THEREOF BEARS NORTH 89 DEGREES 23 MINUTES 30 SECONDS WEST, 267.15 FEET;
THENCE NORTH 00 DEGREES 36 MINUTES 30 SECONDS EAST, A DISTANCE OF 40.00 FEET TO THE POINT OF BEGINNING;
THENCE NORTH 00 DEGREES 36 MINUTES 30 SECONDS EAST, A DISTANCE OF 242.50 FEET;

THENCE NORTH 00 DEGREES 36 MINUTES 30 SECONDS EAST, A DISTANCE OF 242.50 FEET;

THENCE NORTH 89 DEGREES 23 MINUTES 30 SECONDS WEST PARALLEL WITH THE SOUTH LINE OF THE SAID NORTHWEST QUARTER, A

DISTANCE OF 205.15 FEET;
THENCE NORTH 00 DEGREES 06 MINUTES 06 SECONDS WEST PARALLEL WITH THE WEST LINE OF SAID NORTHWEST QUARTER, A DISTANCE

THENCE NORTH 00 DEGREES 06 MINUTES 06 SECONDS WEST PARALLEL WITH THE WEST LINE OF SAID NORTHWEST QUARTER, A DISTANCE OF 135.01 FEET;
THENCE SOUTH 89 DEGREES 23 MINUTES 30 SECONDS EAST PARALLEL WITH THE SOUTH LINE OF SAID NORTHWEST QUARTER, A DISTANCE OF 206.82 FEET:
THENCE NORTH 00 DEGREES 36 MINUTES 30 SECONDS EAST, A DISTANCE OF 212.50 FEET;
THENCE SOUTH SPECERCES 23 MINUTES 30 SECONDS EAST PARALLEL TO THE SOUTH LINE OF SAID NORTHWEST QUARTER A DISTANCE OF 759.69 FEET TO A POINT ON THE EAST LINE OF LOT 5.
THENCE SOUTH SPECERCES 36 MINUTES 30 SECONDS EAST ALONG THE EAST LINE OF LOT 5. A DISTANCE OF 500 10 FEET.

THENCE SOUTH 00 DEGREES 25 MINUTES 20 SECONDS EAST ALONG THE EAST LINE OF LOT 5, A DISTANCE OF 590.10 FEET;

THENCE NORTH 89 DEGREES 23 MINUTES 30 SECONDS WEST PARALLEL TO THE SOUTH LINE OF SAID NORTHWEST QUARTER A DISTANCE OF

THENCE NORTH 99 DEGREES 23 MINUTES 30 SECONDS WEST PARALLEL TO THE SOUTH LINE OF SAID NORTHWEST QUARTER A DISTANCE 770.30 FEET TO THE POINT OF BEGINNING; AND EXCEPT THAT PORTION OF THE NORTHWEST QUARTER OF SAID SECTION 6, TOWNSHIP I SOUTH, RANGE 6 EAST OF THE GILA AND SALT RIVER BASE AND MERIDIAN, MARICOPA COUNTY, ARIZONA, MORE PARTICULARLY DESCRIBED AS FOLLOWS:
BEGINNING AT THE WEST QUARTER CORNER OF SAID SECTION 6, SAID POINT ALSO BEING THE CENTERLINE INTERSECTION OF GILBERT ROAD AND HOUSTON AVENUE:
THENCE SOUTH 99 DEGREES 23 MINUTES 30 SECONDS EAST ALONG THE SOUTH LINE OF SAID NORTHWEST QUARTER AND ALONG THE

THENCE SOUTH 89 DEGREES 23 MINUTES 30 SECONDS EAST ALONG THE SOUTH LINE OF SAID NORTHWEST QUARTER AND ALONG THE CENTERLINE OF SAID NORTHWEST QUARTER AND ALONG THE CENTERLINE OF SAID NORTHWEST QUARTER, AD DISTANCE OF 80.00 FEET TO THE TRUE POINT OF BEGINNING;
THENCE CONTINUING NORTH 00 DEGREES 06 MINUTES 06 SECONDS WEST, A DISTANCE OF 122.98 FEET;
THENCE SOUTH 89 DEGREES 32 MINUTES 30 SECONDS EAST, A DISTANCE OF 203.67 FEET;
THENCE SOUTH 89 DEGREES 36 MINUTES 30 SECONDS WEST, A DISTANCE OF 203.67 FEET;
THENCE SOUTH 00 DEGREES 36 MINUTES 30 SECONDS WEST, A DISTANCE OF 122.97 FEET TO A POINT LYING 40.00 FEET NORTH OF THE SOUTH LINE OF SAID NORTHWEST QUARTER;
THENCE SOUTH 89 DEGREES 32 MINUTES 30 SECONDS WEST PARALLEL TO AND 40.00 FEET NORTH OF THE SOUTH LINE OF SAID NORTHWEST QUARTER;
THENCE NORTH 39 DEGREES 32 MINUTES 30 SECONDS WEST PARALLEL TO AND 40.00 FEET NORTH OF THE SOUTH LINE OF SAID NORTHWEST QUARTER, A DISTANCE OF 202.14 FEET TO THE TRUE POINT OF BEGINNING; AND EXCEPT THAT PORTION OF LOT 5, SECTION 8, TOWNSHIP 1 SOUTH, RANGE 6 EAST OF THE GILA AND SALT RIVER BASE AND MERIDIAN, MARICOPA COUNTY, ARIZONAD DESCRIBER 3A SOUTH OWS:

MARICOPA COUNTY, ARIZONA, DESCRIBED AS FOLLOWS:

BEGINNING AT A POINT ON THE WEST LINE OF THE WEST HALF OF THE NORTHWEST QUARTER OF SAID SECTION 6. FROM WHICH THE SOUTHWEST CORNER THEREOF BEARS SOUTH 00 DEGREES 06 MINUTES 06 SECONDS EAST, 417.53 FEET:

SOUTHWEST CORNER THEREOF BEARS SOUTH 00 DEGREES 06 MINUTES 06 SECONDS EAST, 417.53 FEET;

THENCE SOUTH 89 DEGREES 23 MINUTES 30 SECONDS EAST, PARALLEL TO THE SOUTH LINE OF SAID NORTHWEST QUARTER, A DISTANCE OF
65.00 FEET TO THE TRUE POINT OF BEGINNING;

THENCE NORTH 00 DEGREES 06 MINUTES 06 SECONDS WEST PARALLEL TO THE WEST LINE OF SAID NORTHWEST QUARTER, A DISTANCE OF
222.74 FEET TO THE POINT OF TANGENCY OF A CURVE CONCAVE EASTERLY HAVING A RADIUS OF 1367.70 FEET;

THENCE NORTHERLY ALONG THE ARC OF SAID CURVE THROUGH A CENTRAL ANGLE OF 02 DEGREES 37 MINUTES 35 SECONDS, A DISTANCE

THENCE SOUTH 89 DEGREES 23 MINUTES 30 SECONDS EAST PARALLEL TO THE SOUTH LINE OF SAID NORTHWEST QUARTER, A DISTANCE OF

THENCE SOUTH 00 DEGREES 06 MINUTES 06 SECONDS EAST PARALLEL TO THE WEST LINE OF SAID NORTHWEST QUARTER. A DISTANCE OF


THENCE SOUTH 89 DEGREES 23 MINUTES 30 SECONDS EAST PARALLEL TO THE SOUTH LINE OF SAID NORTHWEST QUARTER, A DISTANCE OF

15.00 FEET;
THENCE SOUTH 00 DEGREES 36 MINUTES 30 SECONDS WEST, A DISTANCE OF 222.73 FEET;
THENCE NORTH 89 DEGREES 23 MINUTES 30 SECONDS WEST PARALLEL TO THE SOUTH LINE OF SAID NORTHWEST QUARTER, A DISTANCE OF 208.82 FEET TO THE POINT OF BEGINNING; AND
EXCEPT THAT PORTION OF THE NORTHWEST QUARTER OF SECTION 6, TOWNSHIP 1 SOUTH, RANGE 6 EAST OF THE GILA AND SALT RIVER BASE AND MERIDIAN, MARICOPA COUNTY, ARIZONA, MORE PARTICULARLY DESCRIBED AS FOLLOWS:

BEGINNING AT THE WEST QUARTER CORNER OF SAID SECTION 6, SAID POINT ALSO BEING THE CENTERLINE INTERSECTION OF GILBERT

ROAD AND HOUSTON AVENUE;
THENCE SOUTH 89 DEGREES 23 MINUTES 30 SECONDS EAST ALONG THE SOUTH LINE OF SAID NORTHWEST QUARTER AND ALONG THE
CENTERLINE OF SAID HOUSTON AVENUE, A DISTANCE OF 65.01 FEET;
THENCE NORTH 00 DEGREES 06 MINUTES 06 SECONDS WEST PARALLEL TO AND 65.00 FEET EAST OF THE WEST LINE OF SAID NORTHWEST
QUARTER A DISTANCE OF 162.99 FEET TO THE TRUE POINT OF BEGINNING;
THENCE CONTINUING NORTH 00 DEGREES 06 MINUTES 06 SECONDS WEST, A DISTANCE OF 119.54 FEET;
THENCE SOUTH 89 DEGREES 23 MINUTES 30 SECONDS EAST PARALLEL TO THE SOUTH LINE OF SAID SECTION 6, A DISTANCE OF 205.15 FEET;
THENCE SOUTH 00 DEGREES 36 MINUTES 30 SECONDS WEST, A DISTANCE OF 203.67 FEET TO THE TRUE POINT OF BEGINNING;
AND

AND
EXCEPT THE WEST 25.0 FEET AS SET FORTH IN WARRANTY DEED RECORDED IN 84-091493, OF OFFICIAL RECORDS AND IN 85-120682, OF
OFFICIAL RECORDS.

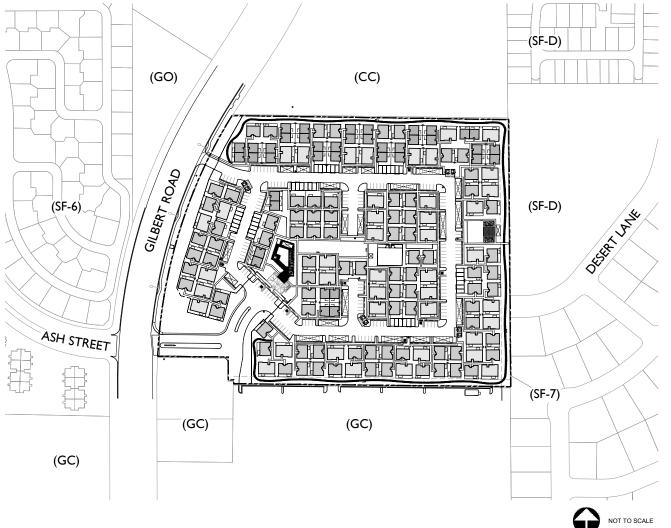

SHEET INDEX

NUMBER	DESCRIPTION
SP.C	COVER SHEET
SP.01	ENLARGED SITE PLAN
SP.D	DETAILS

DEVELOP	IENT STANDARDS
SETBACKS	
FRONT: SIDE (STREET) SIDE (RES.) SIDE (NON-RES.) REAR (RES.) REAR (NON-RES.)	25' 25' 25' 20' 20' 20'
SEPARATION	I BETWEEN BUILDINGS
PER BUNGALOW	10'

PROJECT TEAM

DISCIPLINE	CONTACT INFORMATION
OWNER	ADVANCED ACQUISITIONS, LLC DAVE CAVAN 15300 N. 90TH STREET, SUITE 200 SCOTTSDALE, ARIZONA 85260 480.627.7000
LANDSCAPE ARCHITECT	RVI PLANNING + LANDSCAPE ARCHITECTURE MARK REDDIE 120 S. ASH AVENUE TEMPE, ARIZONA 85281 480.994.0994
CIVIL ENGINEER	HILGART WILSON, LLC GEORGE KRALL 2141 E. HIGHLAND AVENUE, SUITE 250 PHOENIX, ARIZONA 85016 602.490.0535
ARCHITECT	MOORADIAN & ASSOCIATES 4578 N. FIRST AVENUE, SUITE 140 TUCSON, ARIZONA 85718 520-408-8117

PRELIMINARY NOT FOR CONSTRUCTION



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APRIL 7, 2020

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BASELINE RD

HOUSTON AVE

PRELIMINARY SITE ADDRESS:

VICINITY MAP

SITE PLAN	DATA	
GROSS AC. NET AC.	15.91 AC. OR 693,254 S.F. 14.85 AC. OR 646,794 S.F.	
APN#:	304-10-021Y	
EXISTING ZONING:	GC	
PROPOSED ZONING:	MF/L	
PROPOSED USE:	MULTI-FAMILY RESIDENTIAL	
TOTAL # OF UNITS:	1 BEDROOM UNITS: 40 (24%) 2 BEDROOM UNITS: 83 (50%) 3 BEDROOM UNITS: 42 (26%) TOTAL UNITS: 165	
DENSITY (GROSS):	10.37 DU/AC	
PROPOSED BUILDING HEIGHT:	SINGLE STORY	
COMMON OPEN SPACE REQUIRED:	43% OF NET	
PRIVATE OPEN SPACE REQUIRED:	196 SQ. FT. PER UNIT	
OPEN SPACE PROVIDED:	43.5% OF NET (COMMON OS) 281,508 SQ. FT. OR 43.5% (COMMON 53,462 SQ. FT. OR 5.5% (PRIVATE OS	
LOT COVERAGE PROVIDED:	27.8 % (NET) 1 BED- 40 UNITS x 676 SQ. FT. = 2 BED- 83 UNITS x 1,012 SQ. FT. = 3 BED- 42 UNITS x 1,335 SQ. FT. = 0FFICE BUNGALOW TOTAL BUILDING AREA: (180,006) NET SITE AREA= 27.8% LO	83,996 SC 56,910 SC 10,710 SC 1,350 SQ. 180,006 S
REQUIRED PARKING:	1 BED UNIT (1 SPACE PER UNIT) 2 BED UNIT (2 SPACES PER UNIT) 3 BED UNIT (2 SPACES PER UNIT) GUESTS (0.25 SPACES PER UNIT) COVERED (1 SPACE PER UNIT) TOTAL REQUIRED PARKING	84 42 JNIT)
PROPOSED PARKING:	337 SPACES TOTAL INCL. 8 ACCESSIBLE SPACES INCL. 42 GARAGE SPACES INCL. 132 CANOPY SPACES	


OI I		DATE:
INE	CONTACT INFORMATION	DRAWN:
:	ADVANCED ACQUISITIONS, LLC DAVE CAVAN 15300 N. 90TH STREET, SUITE 200 SCOTTSDALE, ARIZONA 85280 480.627.7000 RVI PLANNING + LANDSCAPE ARCHITECTURE MARK REDDIE 120 S. ASH AVENUE TEMPE, ARIZONA 85281 480.994.0994	REVISIONS REVISIONS A A S A
	HILGART WILSON, LLC GEORGE KRALL 2141 E. HIGHLAND AVENUE, SUITE 250 PHOENIX, ARIZONA 85016 602.490.0535 MOORADIAN & ASSOCIATES 4578 N. FIRST AVENUE, SUITE 140	COVE
	TUCCON ADIZONA 95749	,

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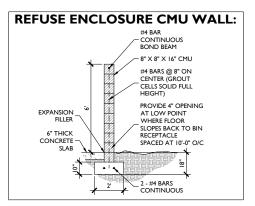
PDR-2019-00143 (4TH REVIEW)

SP.C


SHEET 1 OF 3

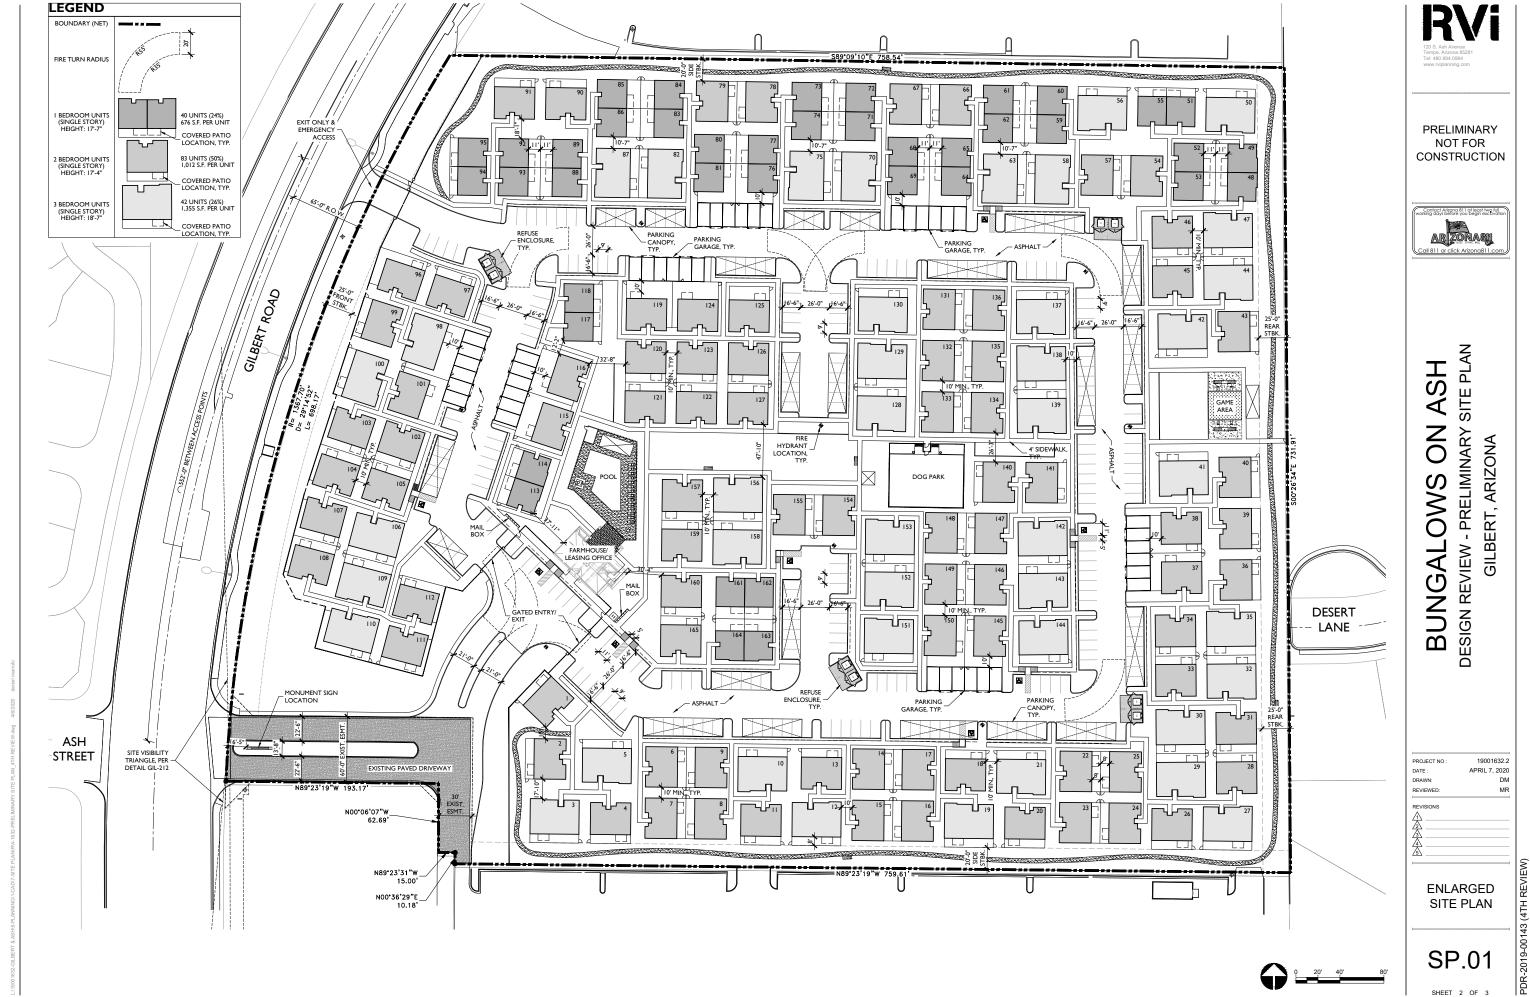


SHEET 2 OF 3



TYPICAL SHADE STRUCTURE/PARKING CANOPY DETAIL:

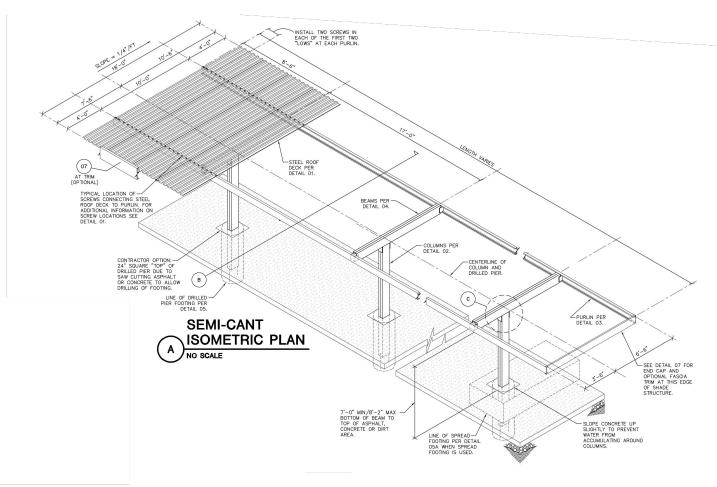

REFUSE ENCLOSURE ELEVATION (FRONT):

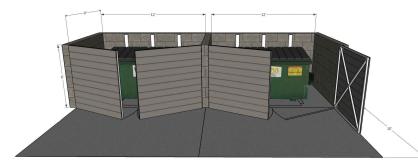

REFUSE ENCLOSURE ELEVATION (LEFT):




SMOOTH FACE BLOCK SW7019 'GAUNTLET GREY' STANDARD GREY BLOCK / SATIN FINISH PAINT ALL BLOCK SIZES PER PLANS & DETAILS. JOINTS SHALL BE CONCAVE. BLOCK SHALL BE PRIMED & PAINTED PER PER MFRS SPEC'S. SUPERLITE BLOCK (1.800.366.7877, www.superliteblock.com)


HERWIN-WILLIAMS (1.800.4.SHERWIN, www.sherwin-williams.com)

REFUSE ENCLOSURE ELEVATION (REAR):






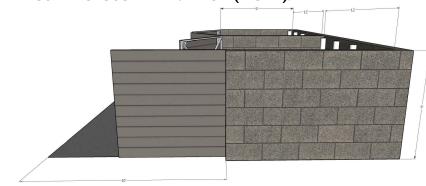

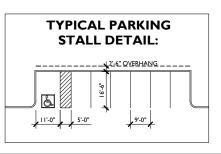






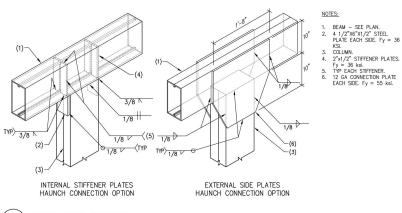

C BEAM TO COLUMN CONNECTION 17-1619 NO SCALE

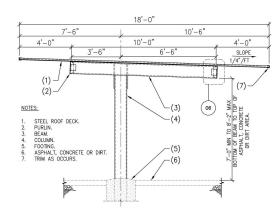

SECTION

DRAWN: REVIEWED

DETAILS

SP.D

PDR-2019-00143 (4TH REVIEW)

SHEET 3 OF 3

DESIGN REVIEW - PRELIMINARY GILBERT, ARIZONA SMO. BUNGAL PROJECT NO 19001632.2 APRIL 7, 2020

PRELIMINARY NOT FOR CONSTRUCTION

SITE PLAN

SH

N O



EXHIBIT ANALYSIS CODE • FIRE



THE BUNGALOWS ON ASH

DESIGN REVIEW CONCEPTUAL LANDSCAPE PLAN

GILBERT, ARIZONA **CAVAN COMPANIES**


GENERAL CONSTRUCTION NOTES

- 2. CONTRACTOR SHALL BE RESPONSIBLE FOR SECURING ALL NECESSARY PERMITS AND SHALL NOTIFY ALL UTILITY COMPANIES WITH UTILITIES ON SITE PRIOR TO THE CONSTRUCTION OF THE PROJECT. CONTRACTOR SHALL ADHERE TO ALL APPLICABLE LOCAL, STATE AND/OR FEDERAL LAWS OR REGULATIONS PERTAINING TO THE PROJECT.
- 3 IN ALL CASES WHERE A CONFLICT MAY OCCUR. SLICH AS RETWEEN ITEMS COVERED IN SPECIFICATIONS AND NOTES ON THE DRAWINGS. ON BETWEEN GENERAL NOTES AND SPECIFIC DETAILS, THE LANDSCAPE ARCHITECT SHALL BE NOTIFIED AND HE OR SHE WIL INTERPRET THE INTENT OF THE CONTRACT DOCUMENTS.
- 4. A QUALIFIED SUPERVISOR SHALL BE PRESENT ON SITE AT ALL TIMES DURING CONSTRUCTION.
- 5. DETAILS NOTED AS "TYPICAL" SHALL APPLY IN ALL CASES UNLESS SPECIFICALLY SHOWN OR NOTED OTHERWISE.
- 6. LANDSCAPE CONTRACTOR SHALL INSPECT WITH THE OWNER'S AUTHORIZED REPRESENTATIVE AND/OR OWNER ALL EXISTING LANDSCAPE CONTRACTOR SHALL INSPECT WITH THE OWNER'S AUTHORIZED REPRESENTATIVE AND/OR OWNER ALL EXISTING CONDITIONS PRIOR TO THE START OF ANY WORK. THE CONTRACTOR SHALL BE RESPONSIBLE UNDER THIS CONTRACT TO REPAIR AND/OR REPLACE, AT THEIR OWN EXPENSE, ANY STRUCTURES, FENCES, WALLS, PLANT MATERIAL, OR OTHER ITEMS DESTROYED DURING CONSTRUCTION. LIKEWISE THE CONTRACTOR SHALL BE RESPONSIBLE FOR REPAIRING AND/OR REPLACING ANY AND ALL DAMAGES TO ADJACENT PROPERTIES OR ANY OTHER AREAS OUTSIDE THE CONTRACT LIMITS. THE DAMAGED ITEMS/AREAS WILL BE RESTORED TO THEIR ORIGINAL CONDITION TO THE SATISFACTION OF THE OWNER'S AND/OR OWNER'S AUTHORIZED REPRESENTATIVE.
- IT IS THE RESPONSIBILITY OF THE CONTRACTOR TO COORDINATE ALL PLANT MATERIAL LOCATIONS WITH OTHER TRADES PRIOR TO INSTALLATION. THE CONTRACTOR SHALL FAMILIARIZE THEMSELVES WITH THE LOCATIONS OF EXISTING AND FUTURE UNDERGROUND SERVICES AND IMPROVEMENTS WHICH MAY CONFLICT WITH THE WORK TO BE DONE. PRIOR TO THE START OF WORK, ALL UNDERGROUND UTILITIES ARE TO BE LOCATED AND PROTECTED, CONTRACTOR IS RESPONSIBLE FOR THE INITIAL CALL AND FUTURE LIPDATES TO BLUE STAKE AT 602-263-1100 EXISTING LINDERGROUND SERVICES SHALL NOT BE DISTURBED OR REMOVED WITHOUT PPROVAL OF THE OWNER'S AND/OR OWNER'S AUTHORIZED REPRESENTATIVE, UNLESS SPECIFICALLY NOTED OTHERWISE ON
- 8. CONTRACTOR SHALL PROVIDE BARRICADES AND TRAFFIC CONTROL ALONG PUBLIC STREETS IF REQUIRED DURING CONSTRUCTION
- 9. PLANTING AND IRRIGATION DESIGN MAY BE MODIFIED TO ADAPT TO WALK CONFIGURATIONS THAT DIFFER FROM THESE PLANS, AND
- 10. REFER TO ENGINEERING PLANS FOR DRAINAGE FLOWS. THE LANDSCAPE CONTRACTOR SHALL BE RESPONSIBLE THAT THESE ARE
- NO PART OF THE CONTRACT DOCUMENTS ARE INTENDED TO BE IN VIOLATION OF CODES. IF DISCREPANCIES EXIST, NOTIFY LANDSCAPE
- 12. COORDINATE AND COOPERATE WITH ALL CONTRACTORS OF ATTACHED, ADJOINING AND/OR INTERFACING WORK TO INSURE ORDERLY AND EFFICIENT COMPLETION OF ALL WORK
- 13. ALL CONSTRUCTION SHALL CONFORM TO ALL APPLICABLE CODES AND ORDINANCES (FEDERAL, STATE, LOCAL, AND HEALTH DEPARTMENTS). EXCEPT WHERE REQUIREMENTS OF CONTRACT DOCUMENTS ARE MOST STRINGENT
- 14. ALL EXISTING PLANT MATERIAL SHALL REMAIN UNLESS OTHERWISE NOTED.
- 15. ANY PLANT MATERIAL THAT MUST BE REMOVED DUE TO CONSTRUCTION MUST BE APPROVED BY OWNER AND/OR OWNER'S AUTHORIZED REPRESENTATIVE. NOTIFY OWNER AND/OR OWNER'S AUTHORIZED REPRESENTATIVE AT LEAST 48 HOURS PRIOR TO REMOVAL AND/OR RELOCATION OF ALL PLANTS.
- 16. IF ANY EXISTING PLANT MATERIAL THAT IS TO REMAIN IS DAMAGED BY CONTRACTOR, THE CONTRACTOR SHALL REPLACE THE DAMAGED PLANT WITH A NEW ONE OF THE SAME SIZE AND VARIETY AT NO COST TO THE OWNER.
- $17. \ \ DO\ NOT\ DISTURB\ SOIL\ WITHIN\ BRANCH\ SPREAD\ OF\ TREES\ OR\ SHRUBS\ TO\ REMAIN\ WITHOUT\ APPROVAL\ OF\ THE\ OWNER\ AND/OR\ SHRUBS\ TO\ REMAIN\ WITHOUT\ APPROVAL\ OF\ THE\ OWNER\ AND/OR\ SHRUBS\ TO\ REMAIN\ WITHOUT\ APPROVAL\ OF\ THE\ OWNER\ AND/OR\ SHRUBS\ TO\ REMAIN\ WITHOUT\ APPROVAL\ OF\ THE\ OWNER\ AND/OR\ SHRUBS\ TO\ REMAIN\ WITHOUT\ APPROVAL\ OF\ THE\ OWNER\ AND/OR\ SHRUBS\ TO\ REMAIN\ WITHOUT\ APPROVAL\ OF\ THE\ OWNER\ AND/OR\ SHRUBS\ TO\ REMAIN\ WITHOUT\ APPROVAL\ OF\ THE\ OWNER\ AND/OR\ SHRUBS\ TO\ REMAIN\ WITHOUT\ APPROVAL\ OF\ THE\ OWNER\ AND/OR\ SHRUBS\ TO\ REMAIN\ WITHOUT\ APPROVAL\ OF\ THE\ OWNER\ AND/OR\ SHRUBS\ TO\ REMAIN\ WITHOUT\ APPROVAL\ OF\ THE\ OWNER\ AND/OR\ SHRUBS\ TO\ REMAIN\ APPROVAL\ OF\ THE\ OWNER\ AND/OR\ SHRUBS\ THE\ OWNER\ AND THE OWNER$
- 18. ANY DISCREPANCIES BETWEEN THE PLANS AND CONDITIONS ON SITE SHALL BE REPORTED IMMEDIATELY TO THE OWNER AND/OR
- 19. CONTRACTOR SHALL PROVIDE OWNER WITH ALL WARRANTY INFORMATION, INSTRUCTION MANUALS AND ANY OTHER PRODUCT INFORMATION FOR ALL NEW EQUIPMENT OR MACHINERY INSTALLED ON THE SITE WITHIN TWO WEEKS AFTER SUBSTANTIAL
- 20. NO DESIGN MODIFICATIONS SHALL BE MADE WITHOUT THE OWNER AND/OR OWNER'S AUTHORIZED REPRESENTATIVE APPROVAL.
- 21. CONTRACTOR SHALL BE RESPONSIBLE FOR HAULING AND LEGALLY DISPOSING OF MATERIALS DESIGNATED TO BE REMOVED. PROVIDE RECEIPTS FOR DUMPING TO OWNER FOR THEIR FILES.
- 22. ALL BASE INFORMATION IS FROM OTHER PROJECT TEAM MEMBERS AS LISTED IN THE 'PROJECT TEAM' LIST ON THIS SHEET. A THOROUGH ATTEMPT HAS BEEN MADE TO KEEP UP TO DATE WITH THE MOST CURRENT BASE INFORMATION. HOWEVER DISCREPANCIES MAY EXIST BETWEEN THESE PLANS AND OTHER TEAM MEMBERS PLANS. IN ALL CASES THE ENGINEERS PLANS SHALL HAVE PRECEDENCE OVER THE LANDSCAPE PLANS FOR FINAL PROJECT CONFIGURATION.
- L SIDEWALKS SHOWN ON THESE PLANS ARE FOR REFERENCE ONLY. REFER TO CIVIL ENGINEERING PLANS FOR FINAL LAYOUT GRADES, FINISHES, DETAILS, AND METHODS OF CONSTRUCTION. RVI UNDER NO CIRCUMSTANCES ASSUMES RESPONSIBILIUNFORESEEN CONFLICTS, ENGINEERING, STRUCTURAL CALCULATIONS, OR INSTALLATION THAT IS BEYOND OUR CONTROL.
- GOVERNING MUNICIPALITY FOR SPECIFIC GUIDELINES. IN CASES WHERE THERE IS MORE THAN ONE GOVERNING BODY, THE MOST RESTRICTIVE GUIDELINE SHALL PREVAIL.
- 25. ALL WALLS AND VERTICAL SITE FEATURES DESIGNED IN THE INTEREST OF THIS PROJECT ARE SCHEMATIC IN NATURE. POTENTIAL CONSTRUCTION DETAILING AND TECHNIQUES ARE SHOWN FOR DESIGN INTENT CLARIFICATION ONLY. THE CONTRACTOR SHALL HAVE THE ULTIMATE RESPONSIBILITY TO ENSURE THAT ALL CONSTRUCTED ELEMENTS ON THIS PROJECT ARE STRUCTURALLY SOUND AND ARE BUILT WITHIN ALL APPLICABLE CITY, STATE, AND FEDERAL GUIDELINES. REVI UNIDER NO CIRCUMSTANCES ASSUMES RESPONSIBILITY FOR UNFORESEEN CONFLICTS, ENGINEERING, STRUCTURAL CALCULATIONS, OR INSTALLATION.
- 26. SHOP DRAWING REVIEWS WILL BE DONE TO ENSURE THAT PRODUCT DATA, MATERIALS, AND SAMPLES MEET OR EXCEED THE ORIGINAL DESIGN INTENT OF THESE DRAWINGS ONLY. RVI UNDER NO CIRCUMSTANCES ASSUMES RESPONSIBILITY FOR UNFORESEEN CONFLICTS, ENGINEERING, STRUCTURAL CALCULATIONS OR INSTALLATION RESULTING FROM THE PRODUCTION OF ANY SHOP DRAWINGS.

SUBMITTAL HISTORY

DATE	DESCRIPTION / COMMENTS
09/16/2019	DESIGN REVIEW
12/11/2019	DESIGN REVIEW 2ND SUBMITTAL
02/17/2020	DESIGN REVIEW 3RD SUBMITTAL
04/07/2020	DESIGN REVIEW 4TH SUBMITTAL

VICINITY MAP

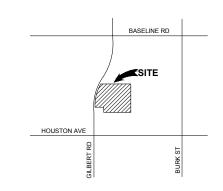

SHEET INDEX

DESCRIPTION NUMBER COVER SHEET WALL PLAN PLANTING NOTES PLANTING PLANS PLANTING PLAN - RENDERED WATER CONSERVATION PLAN HARDSCAPE DETAILS

PROJECT TEAM

DISCIPLINE	CONTACT INFORMATION
OWNER	ADVANCED ACQUISITIONS, LLC DAVE CAVAN 15300 N. 90TH STREET, SUITE 200 SCOTTSDALE, ARIZONA 85260 480.627.7000
LANDSCAPE ARCHITECT	RVI PLANNING + LANDSCAPE ARCHITECTURE MARK REDDIE 120 S. ASH AVENUE TEMPE, ARIZONA 85281 480.994.0994
CIVIL ENGINEER	HILGART WILSON, LLC GEORGE KRALL 2141 E. HIGHLAND AVENUE, SUITE 250 PHOENIX, ARIZONA 85016 602.490.0535
ARCHITECT	MOORADIAN & ASSOCIATES 4578 N. FIRST AVENUE, SUITE 140 TUCSON, ARIZONA 85718 520-408-8117

COMMON ABBREVIATIONS

SYMBOL	DEFINITION	SYMBOL	DEFINITION	SYMBOL	DEFINITION
@	AT	EQ	EQUAL	P/L	PROPERTY LINE
ĀVG	AVERAGE	EX	EXISTING	POC	POINT OF CONNECTION
BPU	BACKFLOW PREVENTION UNIT	FF	FINISH FLOOR	PUE	PUBLIC UTILITY EASEMENT
BTH	BROWN TRUNK HEIGHT	FG	FINISH GRADE	PSI	POUNDS PER SQUARE INCH
BW	BOTTOM OF WALL	FL	FLOW LINE	R, RAD	RADIUS
CAL	CALIPER	FT	FEET	R/W	RIGHT OF WAY (R.O.W.)
CB	CATCH BASIN	GAL	GALLONS	SF	SQUARE FEET
CF	CUBIC FEET	GPH	GALLONS PER HOUR	STD	STANDARD
CJ	CONTROL JOINT	GPM	GALLONS PER MINUTE	SDL	SIGHT DISTANCE LINE
CL	CENTERLINE	HORIZ	HORIZONTAL	SIM	SIMILAR
CLR	CLEAR	HP	HIGH POINT	SJ	SCORE JOINT
CMU	CONCRETE MASONRY UNIT	HT	HEIGHT	SVT	SIGHT VISIBILITY TRIANGLE
CONC	CONCRETE	LF	LINEAR FEET	S/W	S/W
CONT	CONTINUOUS	LOC	LIMIT OF CONSTRUCTION	TBS	TO BE SELECTED
Ø, DIA	DIAMETER	L/S	LANDSCAPE	TW	TOP OF WALL
DG	DECOMPOSED GRANITE	MAX	MAXIMUM	TYP	TYPICAL
EA	EACH	MIN	MINIMUM	VERT	VERTICAL
EJ	EXPANSION JOINT	NTS	NOT TO SCALE	w/	WITH
ELEV	ELEVATION	OC	ON CENTER		

GENERAL SCOPE OF WORK

- CONTRACTOR SHALL PROVIDE ALL LABOR, MATERIALS INCLUDING WATER, EQUIPMENT AND INCIDENTALS AS SHOWN, SPECIFIED AND REQUIRED TO PERFORM LANDSCAPING WORK. THE EXTENT OF THE LANDSCAPING WORK IS SHOWN ON THE DRAWINGS AND IN THE SCHEDULES. THE TYPES OF LANDSCAPING REQUIRED MAY INCLUDE THE FOLLOWING:
- AESTHETIC FINISH GRADING

- AESTHETIC FINISH GRADING
 BOULDER PLACEMENT
 INSTALLATION OF TREES, SHRUBS, GROUNDCOVERS, AND ANY OTHER NURSERY STOCK
 INSTALLATION OF TURF AREAS
 DECOMPOSED GRANITE AND PRE-EMERGENT APPLICATIONS (2)
 MULCHES, AND ALL OTHER MATERIAL NECESSARY TO COMPLETE THE PLANTING JOB AS SPECIFIED
 MISCELLANEOUS LANDSCAPE MATERIALS AND IMPROVEMENTS
 EEDTILIZEDS AND SCILLANDSCAPE MATERIALS AND IMPROVEMENTS
- FERTILIZERS AND SOIL AMENDMENTS
- MAINTENANCE WORK AS SPECIFIED UNTIL COMPLETION OF THE CONTRACT
- OBTAIN ALL PERMITS AND PAY REQUIRED FEES TO ANY GOVERNMENTAL AGENCY HAVING JURISDICTION OVER THE WORK. ARRANGE INSPECTIONS REQUIRED BY LOCAL AGENCIES AND ORDINANCES DURING THE COURSE OF CONSTRUCTION AS REQUIRED.
- COORDINATE AND COOPERATE WITH OTHER CONTRACTORS WORKING ON THE SITE FOR SUCCESSFUL COMPLETION OF THE PROJECT
- 5. BEFORE COMMENCING WORK ON THE SITE, BECOME THOROUGHLY ACQUAINTED WITH LAYOUT OF ALL UNDERGROUND UTILITIES AND STRUCTURES OVER THE ENTIRE SITE. ALL REQUISITE REPAIRS TO DAMAGE CAUSED BY WORK OF THIS SECTION SHALL BE AT THE
- THE IRRIGATION WORK CONSISTS OF INSTALLING A COMPLETE LINDERGROUND SPRINKLER, EMITTER, AND BURBLER SYSTEM FOR ALL THE IRRIGATION WORK CONSISTS OF INSTALLING A COMPLETE UNDERGROUND SPRINKLER, EMITTER, AND BUBBLER SYSTEM FOR ALL TURF AND LANDSCAPED AREAS AS SHOWN ON THE DRAWINGS AND AS HEREINBAFTER SPECIFIC, INCLUDING THE FURNISHING OF ALL LABOR, EQUIPMENT, APPLIANCES, AND MATERIALS INCLUDING WATER AND IN PERFORMING ALL OPERATION IN CONNECTION WITH THE CONSTRUCTION OF THE IRRIGATION SYSTEM. WORK SHALL INCLUDE FURNISHING AND INSTALLING ALL PLASTIC AND COPPER PIPE AND FIFTINGS, AUTOMATIC CONTROL VALVES, VALVE ACCESS BOXES, ELECTRIC COMPUTERIZED CENTRAL CONTROLLERS, ELECTRIC WIRE. TELEPHONE ACCESS LING (IF REQUIRED), ETC., AS REQUIRED FOR A COMPLETE SYSTEM AS SHOWN ON THE DRAWINGS AND AS CALLED FOR IN THESE SPECIFICATIONS OR AS MAY BE REQUIRED FOR PROPER OPERATION OF THE SYSTEM. THE CONTRACTOR IS DESCRIBED BY EACH OF THE SYSTEM AS THE CONTRACTOR IS RESPONSIBLE FOR ALL COSTS OF WATER USED IN CONNECTION WITH THE INSTALLATION OF THE IRRIGATION SYSTEM.
- 7 LINESS OTHERWISE SPECIFIED OR INDICATED ON THE DRAWINGS. THE CONSTRUCTION OF THE IRRIGATION SYSTEM SHALL INCLUDE THE FURNISHING INSTALLING AND TESTING OF ALL MAINS LATERALS RISERS AND FITTINGS THE FURNISH THE FORNISHING, INSTALLING AND TESTING OF ALL MAINS, LATERALS, RISERS, AND FITTINGS, THE FORNISHING AND INSTALLING OF IRRIGATION HEADS, CONTROL LAYES, CONTROLLERS, LOW AND HIGH VOLTAGE ELECTRIC WHE, TELEPHONE ACCESS LINE TO CENTRAL CONTROL UNIT (IF REQUIRED), POINT OF CONNECTION, CONTROLS, RESTORATION OF EXISTING IMPROVEMENTS, EXCAVATION AND BACKFILL, AND ALL OTHER WORK IN ACCORDANCE WITH THE PLANS AND SPECIFICATIONS AS REQUIRED FOR A COMPLETE SYSTEM.
- 8. WHENEVER ANY MATERIAL IS SPECIFIED BY NAME AND/OR NUMBER, SUCH SPECIFICATIONS SHALL BE DEEMED TO BE USED FOR THE TO BE FOLLOWED BY THE WORDS "OR APPROVED EQUAL." NO SUBSTITUTIONS WILL BE PERMITTED WHICH HAVE NOT BEEN SUBMITTED FOR APPROVAL PRIOR TO BIDDING.
- 9. LANDSCAPE CONTRACTOR SHALL CALL FOR "BLUE STAKE" AS REQUIRED. EXERCISE EXTREME CAUTION IN ALL PLANTING OPERATIONS, AS THERE MAY BE UNDERGROUND ELECTRIC AND TELEPHONE CABLES, SEWER LINES AND WATER LINES THROUGHOUT THE ENTIRE AREA. CONTRACTOR SHALL STUDY AND BE FAMILLAR WITH THE LOCATION OF THESE OBSTRUCTIONS AND UNDERGROUND UTILITIES. PLACE PLANTINGS WHERE SHOWN ON THE PLANS. IF THERE ARE OBSTRUCTIONS OR UNDERGROUND UTILITIES, RELOCATE PLANTS CLEAR OF ANY INTERFERENCE. LANDSCAPE CONTRACTOR SHALL REPAIR ALL DAMAGES CAUSED BY THEM TO OBSTRUCTIONS AND INDEPENDING HEIGHT STATE OF ANY INTERFERENCE. UNDERGROUND UTILITIES AT NO EXPENSE TO THE OWNER.
- 10. MAINTAIN UNINTERRUPTED WATER SERVICE TO BUILDING DURING NORMAL WORKING HOURS. ARRANGE FOR TEMPORARY WATER SHUT-OFF WITH ARCHITECT/ENGINEER DURING INSTALLATION OF IRRIGATION SYSTEM, IF NECESSARY
- 11. ALL WORK AND MATERIALS TO BE IN FULL ACCORDANCE WITH THE LATEST RULES AND REGULATIONS OF SAFETY ORDERS OF DIVISION OF INDUSTRIAL SAFETY; THE UNIFORM BUILDING CODE, M.A.G. SPECIFICATIONS AND OTHER APPLICABLE LAWS OR REGULATIONS, INCLUDING ALL CITY CODES. NOTHING IN THESE SPECIFICATIONS IS TO BE CONSTRUED TO PERMIT WORK NOT CONFORMING TO THESE CODES, SHOULD THE CONSTRUCTION DOCUMENTS, OR INSTRUCTION, BE AT VARIANCE WITH THE AFOREMENTIONED RULES AND REGULATIONS, NOTIFY LANDSCAPE ARCHITECT AND GET INSTRUCTIONS BEFORE PROCEEDING WITH THE WORK AFFECTED. IF LANDSCAPE ARCHITECT IS NOT NOTIFIED OF ANY VARIANCE IT SHALL BE UNDERSTOOD THAT THE CONTRACTOR ASSUMES ANY AND ALL RESPONSIBILITY FOR THE WORK DONE.
- 12. CLEAN UP SHALL BE MADE DAILY AS EACH PORTION OF THE WORK PROGRESSES. REFUSE AND EXCESS DIRT SHALL BE REMOVED FROM CONDITIONS AT CONTRACTOR'S EXPENSE. LEAVE WORK IN CLEAN CONDITION.
- SUBMIT DETAILED OPERATION AND MAINTENANCE DATA FOR ALL EQUIPMENT AND ACCESSORIES PROVIDED UNDER THESE PLANS INCLUDING ASSEMBLY AND PART LISTS FOR EACH TYPE OF VALVE, EMITTER, ETC., FURNISHED TO THE ENGINEER/OWNER'S REPRESENTATIVE.

CONSTRUCTION







PRELIMINARY
NOT FOR
CONSTRUCTION



ON ASH THE BUNGALOWS ON A CONCEPTUAL LANDSCAPE PLAN GILBERT, ARIZONA

19001632 04/06/2020 TB,RT MR

RENDERED PLANTING PLAN

L2.07

LEGEND

■ ■ ■ 8' THEME WALL

▲ ▲ ▲ & 8' PARTIAL VIEW WALL

---- 8' FULL VIEW FENCE

● ● ● 8' BUILDER WALL - PERIMETER

--- 6' INTERNAL BUILDER WALL - UNIT SEPARATION



ALL WALL LOCATIONS AND ALIGNMENTS ARE SCHEMATIC. WALLS SHALL NOT BE INSTALLED IN RIGHT-OF-WAYS, UTILITY EASEMENTS, OR SIGHT

VISIBILITY TRIANGLES. CONTRACTOR TO STAKE WALL CORNERS AND TURN POINTS AND GET CLIENT AND/OR LANDSCAPE ARCHITECT APPROVAL PRIOR TO INSTALLATION.

WALL NOTES

- 1. THESE NOTES ARE GENERAL AND MAY BE SUPERSEDED BY EITHER THE SPECIFICATIONS OR LOCAL TRADE PRACTICES.
- 3. THE EXPOSED UPPERMOST SOIL TO RECEIVE FILL SHALL BE SCARIFIED 6" DEEP, MOISTURE CONDITIONED TO ±3% OF OPTIMUM DENSITY CURVE FOR EACH TYPE OF SOIL ENCOUNTERED AND COMPACTED TO 95% OF MAXIMUM DRY DENSITY PER ASTM D-2922 OR D-3017.
- FILL MATERIAL SHALL BE PREDOMINANTLY GRANULAR, NON-EXPANSIVE, CLEAN OF ALL ORGANIC OR DETRITUS SUBSTANCES, AND HAVE A PLASTICITY INDEX LESS THAN SEVEN (7). BACKFILL SHALL BE COMPACTED TO 95% OF MAXIMUM DENSITY IN HORIZONTAL 8" LIFTS.
- 5. EXCAVATIONS FOR FOUNDATIONS SHALL BE NEAT TO LINES OF FOOTINGS. ALL LOOSE MATERIAL SHALL BE REMOVED FROM SURFACE TO RECEIVE CONCRETE.
- 6. ALLOWABLE SOIL BEARING PRESSURES AT FOOTING ON COMPACTED SOIL: 1500 PSI.
- 7. CONCRETE MIX DESIGN FOR FOOTINGS SHALL BE MAG CLASS 'B' (2500 PSI). UNLESS OTHERWISE NOTED ON DRAWINGS
- 8. NO PIPES OR DUCTS SHALL BE PLACED IN STRUCTURAL CONCRETE UNLESS SPECIFICALLY DETAILED.
- 9. CONCRETE FOOTINGS SHALL BE CONTINUOUS POUR TO GREATEST EXTENT PRACTICAL. STEP FOOTINGS IN EVEN BLOCK INCREMENTS.
- 10. WALL CONTRACTOR TO BE RESPONSIBLE FOR STRUCTURAL CALCULATIONS OF THE WALLS.
- 11. SUBMIT TEST REPORTS FOR CONCRETE MIX DESIGNS TO LANDSCAPE ARCHITECT FOR REVIEW
- 12. WATERPROOF AND GROUT SOLID RETAINING WALLS TO HIGH GRADE, IF APPLICABLE
- 13. ALL IRON/STEEL WORK TO BE OF HIGHEST QUALITY WITH WELDS GROUND SMOOTH. ALL IRON WORK, EXCEPT WHERE NOTED, TO BE PRIMED AND PAINTED. PAINT COLOR TO BE SELECTED BY OWNER AND/OR LANDSCAPE ARCHITECT.
- 14. VERIFY HEIGHTS AND SLOPES AND TURNDOWNS BEFORE POURING FOOTINGS.
- 15. NEW WALL FINISHES SHALL MATCH EXISTING SURFACES, UNLESS OTHERWISE NOTED ON DRAWINGS.
- 16. GROUT SOLID ALL CMU CELLS AND VOIDS BELOW GRADE AND/OR CONTAINING REBAR

EXPIRES 03/31/20 LANDSCAPA **PRELIMINARY** NOT FOR CONSTRUCTION 170MA US/



SH LANDSCAPE PLAN Z O GILBERT, ARIZONA SMO. BUNGAL CONCEPTUAL

PROJECT NO 04/06/2020 TB.RT REVIEWED

WALL PLAN

L1.00

SHEET 2 OF 13

PLANTING GENERAL NOTES

- VERIFY PLANT QUANTITIES PRIOR TO BIDDING AND INSTALLATION. QUANTITIES ARE LISTED FOR CONVENIENCE ONLY, THE ACTUAL NUMBER OF SYMBOLS INDICATED ON THE PLANTING PLANS SHALL HAVE PRIORITY OVER QUANTITIES LISTED WITHIN THE LANDSCAPE MATERIAL SCHEDULE. THE CONTRACTOR SHALL FURNISH ALL PLANT MATERIAL NECESSARY TO COMPLETE THE PLANTINGS AS SHOWN ON THE PLANS.
- 2. CLARIFICATION OF DISCREPANCIES BETWEEN THE CONSTRUCTION DOCUMENTS AND THE SITE SHOULD BE BROUGHT TO THE ATTENTION OF THE LANDSCAPE ARCHITECT AND/OR OWNER'S AUTHORIZED REPRESENTATIVE IMMEDIATELY.
- 3. THE LANDSCAPE ARCHITECT AND/OR OWNER'S AUTHORIZED REPRESENTATIVE IS TO APPROVE ANY PLANT MATERIAL SUBSTITUTIONS.
- ALL PLANT MATERIAL MUST BE MAINTAINED IN HEALTH AND VIGOR, AND BE ALLOWED TO ATTAIN NATURAL SIZE AND SHAPE IN
 ACCORDANCE WITH ARIZONA NURSERY ASSOCIATION SPECIFICATIONS.
- 5. ALL PLANT MATERIAL MAY BE INSPECTED PRIOR TO ACCEPTANCE. THE LANDSCAPE ARCHITECT AND/OR OWNER'S AUTHORIZED REPRESENTATIVE RESERVES THE RIGHT TO REFUSE ANY PLANT MATERIAL DEEMED UNACCEPTABLE, EVEN AFTER DELIVERY TO SITE.
- 6. PLANT TREES AND SHRUBS PLUMB AND FACED TO GIVE THE BEST APPEARANCE OR RELATIONSHIP TO ADJACENT PLANTS, STRUCTURES, AND VIEWS. IF ANY SOIL NUTRIENT DEFICIENCIES EXIST, IT SHALL BE THE RESPONSIBILITY OF THE CONTRACTOR TO AMEND THE SOIL.
- 7. PLANTING METHODS, SOIL AMENDMENT QUANTITIES (IF ANY), AND PREPARATION METHODS SHALL BE INSTALLED ACCORDING TO THE PLANTING SPECIFICATIONS AND DETAILS.
- ALL PLANTING AREAS SHALL RECEIVE WEED CONTROL/PRE-EMERGENT PER THE GUIDELINES SET FORTH WITHIN THE SPECIFICATIONS AND DETAILS. REAPPLY AS NECESSARY TO COMPLETELY KILL NOXIOUS MATERIAL. REMOVE ALL DEAD AND/OR DYING DEBRIS PRIOR TO FINAL ACCEPTANCE
- 9. ALL TREES LOCATED WITHIN SIGHT DISTANCE AREAS MUST BE TRIMMED TO 6'-0" CLEARANCE ABOVE FINISHED GRADE.
- 10. UNLESS OTHERWISE NOTED ON PLANS, ROCK/BARK MULCH SHALL EXTEND UNDER ALL PLANTINGS AND BE RAKED UNIFORMLY ALONG CONCRETE FLATWORK, CURBS AND ETC.
- 11. THE FINISH GRADE OF LANDSCAPE AREAS RECEIVING ROCK/BARK MULCH MUST BE GRADED 2-1/2" BELOW CONCRETE OR OTHER ADJACENT PAYED SURFACES PRIOR TO INSTALLATION OF THE MULCH. FINISH GRADE OF LANDSCAPE AREAS RECEIVING TURF MUST BE GRADED 1-1/2" BELOW CONCRETE OR OTHER PAYED SURFACES PRIOR TO INSTALLATION OF TURF.
- 12. BOULDERS, IF USED, TO BE SURFACE SELECT GRANITE WITH A MINIMUM OF SHARP EDGES AND/OR CRACKING. ANY EXPOSED SURFACE SCARRING THAT MAY HAVE OCCURRED DURING TRANSPORTING OR CONSTRUCTION IS TO BE EONITED WITH NO ADDITIONAL COST TO THE OWNER.
- 13. STAKE ALL NURSERY GROWN TREE STOCK A MINIMUM OF 12" OUT FROM EDGE OF PLANTING WELL. THE EDGE OF ALL TREE PLANTING WELLS SHALL BE A MINIMUM OF 2 FEET AWAY FROM ALL CURB AND SIDEWALKS AND A MINIMUM OF 12 FEET AWAY FROM ALL BUILDING FOUNDATIONS. THE EDGE OF ALL SHRUB PLANTING WELLS SHALL BE A MINIMUM OF 18" AWAY FROM ALL CURB AND SIDEWALKS AND A MINIMUM OF 3 FEET AWAY FROM ALL BUILDING FOUNDATIONS.
- 14. LANDSCAPE CONTRACTOR SHALL CONTACT THE OWNER'S AUTHORIZED REPRESENTATIVE PRIOR TO EACH APPLICATION OF PRE-EMERGENT FOR VERIFICATION. CONTRACTOR SHALL PROVIDE OWNER WITH PROOF OF PRE-EMERGENT APPLICATION NO MORE THAN 7 DAYS AFTER EACH APPLICATION WITHOUT EXCEPTION.
- 15. ALL TREES WITHIN TURF AREAS SHALL BE INSTALLED WITH TEMPORARY PVC ARBOR GUARDS.
- 16. ALL TURF AREAS SHALL BE GRADED SMOOTH AND APPROVED BY THE OWNER'S AUTHORIZED REPRESENTATIVE PRIOR TO INSTALLING SOD OR SEED. ALL AREAS TO RECEIVE TURF SHALL BE COMPLETELY FREE OF ANY RUTS, TRENCH SETTLING, OR ANY MATERIAL OVER 1/2" IN DIAMETER PRIOR TO SOD OR SEED INSTALLATION.
- 17. LANDSCAPE CONTRACTOR IS REQUIRED TO OBTAIN ANY REQUIRED PERMITS FOR ALL ON-SITE AND OFF-SITE IMPROVEMENTS OUTLINED WITHIN THIS SET OF PLANS AND/OR ANY OTHER ADDITIONAL WORK THEY MAY PERFORM IN THE INTEREST OF THIS PROJECT.
- 18. ROCK/BARK MULCH SHALL BE AS SPECIFIED IN THE LANDSCAPE MATERIAL SCHEDULE. ALL PLANTING AREAS, UNLESS OTHERWISE NOTED ON THE PLANS, SHALL RECEIVE A UNIFORM APPLICATION OF THE SPECIFIED MATERIAL. CONTRACTOR SHALLS UBMIT A SAMPLE TO THE OWNER'S AUTHORIZED REPRESENTATIVE PRIOR TO SCHEDULING MASS DELIVERY. OWNER MAY REQUEST THAT AN INITIAL LOAD OF MATERIAL BE DELIVERED TO THE SITE AND BE SPREAD BY THE LANDSCAPE CONTRACTOR FOR THE OWNER'S APPROVAL PRIOR TO MATERIAL APPLICATION ON THE REMAINDER OF THE SITE.
- 19. IT SHALL BE THE RESPONSIBILITY OF THE LANDSCAPE CONTRACTOR TO COORDINATE WITH THE OWNER THE FINAL LAYOUT OF ALL HARDSCAPE ITEMS FOR THIS PROJECT. OWNER MAY REQUEST ALL HARDSCAPE ITEMS (HEADERS, SIDEWALKS, FLATWORK, ETC.) BE STAKED AND/OR CHALKED OUT FOR THEIR APPROVAL PRIOR TO INITIAL POUR.
- 20. LANDSCAPE CONTRACTOR SHALL PRUNE ALL TREES AFTER INSTALLATION SO THAT NO BRANCH IS TOUCHING FINAL GRADE AND TRIM CANOPIES/BRANCHING TO A CLEAN AND NEAT APPEARANCE. ALL DEAD AND/OR DYING MATERIAL SHALL BE PRUNED FROM THE TREE PRIOR TO PINAL ACCEPTANCE.
- 21. WATER TEST ALL TREE PLANTING WELLS PRIOR TO PLANTING. IF TREE WELLS DO NOT PROPERLY DRAIN, REFER TO THE HARDPAN PLANTING DETAIL FOR ADDITIONAL INFORMATION.
- 22. REFER TO GENERAL CONSTRUCTION NOTES ON THE COVER SHEET FOR ADDITIONAL INFORMATION THAT RELATES TO THE SCOPE OF WORK IN THIS SECTION. ALSO REFER TO ANY WRITTEN SPECIFICATION, SHOULD THEY ACCOMPANY THESE DRAWINGS, FOR ADDITIONAL REQUIREMENTS NOT COVERED WITHIN THESE PLANS.


PLANTING WARRANTY & MAINTENANCE NOTES

- I. MAINTAIN ALL AREAS INCLUDED IN THE CONTRACT ON A WEEKLY BASIS DURING THE PROGRESS OF WORK, A 90 DAY MAINTENANCE PERIOD. AND UNTIL THE FINAL ACCEPTANCE OF WORK IS RECEIVED IN WRITING.
- 2. UPON ACCEPTANCE AFTER THE 90 DAY MAINTENANCE PERIOD, THE CONTRACTOR SHALL FURNISH A WRITTEN WARRANTY ON ALL PLANT MATERIAL AGREEING TO GUARANTEE THE CONTINUED GROWTH OF ACTIVE PLANT MATERIAL FOR THE SPECIFIED GUARANTEE PERIODS. ALL GUARANTEE PERIODS COMMENCE FROM THE TIME OF FINAL ACCEPTANCE AT THE END OF THE MAINTENANCE PERIOD.
- 3. THE CONTRACTOR SHALL WATER AND MAINTAIN ALL LANDSCAPE MATERIAL DURING THE MAINTENANCE PERIOD. THE OWNER WILL WATER AND MAINTAIN THE LANDSCAPE MATERIAL DURING THE WARRANTY PERIOD. THE CONTRACTOR SHALL INSPECT THE LANDSCAPE MATERIALS PERIODICALLY DURING THE WARRANTY PERIOD AND SHALL NOTIFY THE OWNER IN WRITING, IF, IN THE CONTRACTOR'S OPINION, THE LANDSCAPE MATERIALS ARE NOT RECEIVING PROPER CARE.
- 4. ALL TREES, PALMS, CACTI, ACCENTS, AND TURF SHALL BE GUARANTEED FOR A MINIMUM PERIOD OF ONE (1) YEAR AND ALL SHRUBS, GROUNDCOVERS, AND OTHER NON SPECIFIED PLANT MATERIAL SHALL BE GUARANTEED FOR A PERIOD OF 90 DAYS FROM THE DATE OF FINAL ACCEPTANCE. THE GUARANTEE SHALL BE AGAINST DEFECTS INCLUDING DEATH AND UNSATISFACTORY GROWTH, EXCEPT FOR DEFECTS RESULTING FROM NEGLECT BY OWNER, ABUSE BY OTHERS, OR UNUSUAL PHENOMENA OR INCIDENTS WHICH ARE BEYOND THE LANDSCAPE CONTRACTOR'S CONTROL.
- 5. ANY PLANT MATERIALS WHICH ARE NOT APPROVED PRIOR TO OCTOBER I OF THE CALENDAR YEAR IN WHICH THEY ARE INSTALLED, SHALL BE FURTHER GUARANTEED UNTIL MAY IS OF THE FOLLOWING CALENDAR YEAR.
- 6. ALL PLANT MATERIALS MUST BE MAINTAINED IN HEALTH AND VIGOR AND BE ALLOWED TO ATTAIN NATURAL SIZE AND SHAPE IN ACCORDANCE WITH THE ORIGINALLY APPROVED LANDSCAPE PLAN.
- 7. REFER TO BOOK SPECIFICATIONS, IF INCLUDED IN THIS DOCUMENT SET, FOR ADDITIONAL INFORMATION ON THE SPECIFICS OF THE ANTICIPATED WARRANTY
- 8. LANDSCAPE CONTRACTOR SHALL PREPARE AND SUBMIT TO THE OWNER TYPEWRITTEN MAINTENANCE GUIDELINES AT FINAL WALK-THRU AND PRIOR TO FINAL ACCEPTANCE OF WORK.
- 9. IF TURF IS USED ON THIS PROJECT THE LANDSCAPE CONTRACTOR SHALL REAPPLY SEED OR SOD IN ALL AREAS WHICH HAVE DEVELOPED BARE SPOTS HALFWAY THROUGH THE MAINTENANCE PERIOD. AREAS WHICH CANNOT BE RESEEDED FOR SUMMER GROWTH DUE TO CONTRACTORS INABILITY TO RESEED DURING PROPER GROWING SEASON SHALL BE OVERSEEDED OR SODDED WITH GRASS APPROPRIATE FOR THE CURRENT SEASON, CARED FOR THROUGHOUT THE OFF SEASON, AND PROPERLY SEEDED AT THE NEXT APPROPRIATE GROWING SEASON. THESE ARRANGEMENTS MUST BE MADE WITH THE OWNER PRIOR TO CONDITIONAL ACCEPTANCE OF THE WORK AND MAY REQUIRE A MONETARY HOLD-BACK.
- 10. COST FOR REPLACEMENTS DURING THE WARRANTY PERIOD IS ASSUMED PART OF THE BID QUOTATIONS AND THEREFORE WILL NOT RESULT IN ANY ADDITIONAL COST TO THE OWNER OR LANDSCAPE ARCHITECT.

EXISTING LANDSCAPE NOTES

- BEFORE WORK BEGINS ON THE PROJECT, THE LANDSCAPE CONTRACTOR SHALL SCHEDULE A PRE-CONSTRUCTION CONFERENCE WITH OWNER AND/OR THE GENERAL CONTRACTOR TO REVIEW THE PROJECT. THE OWNER AND/OR OWNER'S AUTHORIZED REPRESENTATIVE IS TO APPROVE ANY CHANGES PRIOR TO THE START OF ANY WORK.
- 2. ALL DEMOLITION AREAS SHALL BE FLAGGED FOR APPROVAL PRIOR TO DEMOLITION.
- ALL EXISTING PLANT MATERIAL SHALL REMAIN UNLESS OTHERWISE NOTED. SHOULD ANY CONFLICTS ARISE BETWEEN THE EXISTING PLANT MATERIAL ON-SITE AND PROPOSED IMPROVEMENTS SHOWN ON THE PLANS THE CONTRACTOR SHALL NOTIFY THE LANDSCAPE ARCHITECT IMMEDIATELY.

LANDSCAPE MATERIAL SCHEDULE

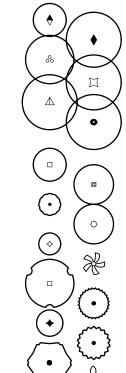

SHADE TREES TEM	SIZE	QTY.	COMMENTS
Fraxinus greggii LITTLE LEAF ASH	24" BOX	5	
Fraxinus velutina 'Fan-Tex' FAN-TEX ASH	24" BOX	10	
Parkinsonia x 'Desert Museum' DESERT MUSEUM PALO VERDE	24" BOX	27	
Pistacia x 'Red Push' RED PUSH PISTACHE	24" BOX	16	
Prosopis glandulosa 'Thornless AZT' THORNLESS HONEY MESQUITE	24" BOX	13	
Ulmus parvifolia 'Sempervirens' CHINESE EVERGREEN ELM	24" BOX	62	
ACCENT/ORNAMENTAL TREES	SIZE	QTY.	COMMENTS
Acacia aneura MULGA	24" BOX	17	
Acacia salicina WILLOW ACACIA	24" BOX	62	
Bauhinia lunarioides ANACACHO ORCHID	24" BOX	83	
Caesalpinia cacalaco 'Smoothie' TM CASCALOTE	24" BOX	4	
Caesalpinia mexicana MEXICAN BIRD-OF-PARADISE	24" BOX	38	
Chamaerops humilis MEDITERRANEAN FAN PALM	24" BOX	10	
Chitalpa tashkentensis PINK DAWN CHITALPA	24" BOX	6	
Cordia boisserii TEXAS OLIVE	24" BOX	12	
Pistacia lentiscus MASTIC TREE	24" BOX	41	
Sophora secundiflora TEXAS MOUNTAIN LAUREL	24" BOX	6	
Vitex agnus-castus CHASTE TREE	24" BOX	9	
Washingtonia robusta MEXICAN FAN PALM	16' B.T.H.	32	

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ITEM Shrubs	SIZE	QTY.	COMMENTS
Bougainvillea x 'Torch Glow'	5 GAL.	33	
TORCH GLOW BUSH BOUGAINVILLEA Caesalpinia mexicana	15 GAL.	8	
MEXICAN BIRD-OF-PARADISE Caesalpinia pulcherrima	5 GAL.	76	
RED BIRD-OF-PARADISE			
Calliandra californica RED BAJA FAIRY DUSTER	5 GAL.	68	
Callistemon viminalis 'Little John'	5 GAL.	74	
LITTLE JOHN BOTTLEBRUSH Cassia artemisioides	5 GAL.	77	
FEATHERY CASSIA	5 GAL.	84	
Cassia phyllodinea SILVERY CASSIA			
Dodonaea viscosa 'Green' GREEN HOPSEED BUSH	5 GAL.	58	
Eremophila glabra carnosa	5 GAL.	137	
WINTER BLAZE EMU BUSH Eremophila hygrophana 'Blue Bells'	5 GAL.	120	
BLUE BELLS			
Eremophila maculata 'Valentine' VALENTINE BUSH	5 GAL.	148	
eucophyllum laevigatum	5 GAL.	82	
CHIHUAHUAN SAGE Leucophyllum langmaniae 'Lynn's Legacy'	5 GAL.	255	
LYNN'S LEGACY TEXAS SAGE	E CAL	78	
Myrtus communis 'Compacta' DWARF MYRTLE	5 GAL.		
Nandina domestica 'Nana' DWARF HEAVENLY BAMBOO	5 GAL.	30	
Ruellia brittoniana	5 GAL.	247	
BRITISH RUELLIA Ruellia penninsularis	5 GAL.	152	
DESERT RUELLIA			
Tecoma x 'Orange Jubilee' ORANGE JUBILEE YELLOW BELLS	5 GAL.	80	
Tecomaria capensis	5 GAL.	61	
CAPE HONEYSUCKLE ACCENTS			
Aloe striata	5 GAL.	15	
CORAL ALOE Aloe X 'Blue Elf'	3 GAL.	63	
BLUE ELF ALOE			
Bouteloua gracilis BLUE GRAMA	5 GAL.	86	
Hesperaloe funifera	5 GAL.	74	
GIANT HESPERALOE Hesperaloe parviflora	5 GAL.	92	
RED YUCCA			
Hesperaloe parviflora 'Perpa' BRAKELIGHTS RED YUCCA	5 GAL.	78	
Muhlenbergia capillaris	5 GAL.	131	
'REGAL MIST' Muhlenbergia emersleyi	5 GAL.	66	
'EL TORO' GRASS Muhlenbergia lindheimeri	5 GAL.	114	
'AUTUMN GLOW'			
Pedilanthus macrocarpus SLIPPER PLANT	5 GAL.	33	
Yucca pallida	5 GAL.	34	
PALE LEAF YUCCA GROUNDCOVERS			
Acacia redolens 'Desert Carpet' TM	1 GAL.	70	
DESERT CARPET ACACIA			
Eremophila glabra 'Mingenew Gold' OUTBACK SUNRISE	1 GAL.	102	
Lantana camara 'New Gold'	1 GAL.	224	
NEW GOLD LANTANA Lantana montividensis	1 GAL.	129	
PURPLE TRAILING LANTANA Rosmarinus officinalis 'Prostratus'	1 GAL.	218	
PROSTRATE ROSEMARY		210	
Wedelia trilobata YELLOW DOT	1 GAL.	31	
VINES			
Bougainvillea 'Barbara Karst'	5 GAL.	22	Staked
BARBARA KARST BOUGAINVILLEA			
MISCELLANEOUS	SIZE	OTY	COMMENTS
TEM	SIZE	QTY.	COMMENTS
Cynodon dactylon 'Midiron' BERMUDA GRASS	SOD	14,960 S.F.	
ROCK MULCH	1/2"	208,787 S.F.	2" DEPTH, FIELD
PALO VERDE BROWN GRANITE	3/2" SCREENED	200,101 J.F.	REAR YARD SF
ARTIFICIAL TURF		770 S.F.	
AKTII ICIAL TURF		110 S.F.	
4' WIDE DG TRAIL	1/4" MINUS	9,515 S.F.	
* WIDE DG TRAIL	1/4 WIINUS	a,513 S.F.	
CONCRETE HEADER	6" x 4"	x L.F.	FIELD VERIFY L.
SOME TE HEADEN	5 A 4	A L.I .	DETAIL 6 / L2.01

SITE PLAN DATA

GROSS AC. NET AC.	15.91 AC. OR 693,254 S.F. 14.85 AC. OR 646,794 S.F.
LANDSCAPE AREA: R.O.W. (OFF-SITE) ON-SITE (COMMON AREA)	8,326 S.F. (1% OF NET AREA) 209,500 S.F. (32% OF NET AREA)

120 S. Ash Avenue Tempe, Arizona 85281 Tel: 480.994.0994

EXPIRES 03/31/20
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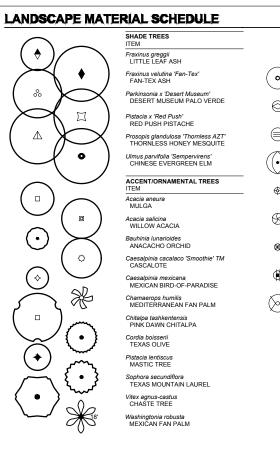
4E BUNGALOWS ON ASI CONCEPTUAL LANDSCAPE PLAN GILBERT, ARIZONA

PROJECT NO: 19001632
DATE: 04/06/2020
DRAWN: TB,RT
REVIEWED: MR
REVISIONS

PLANTING NOTES

2.00


SHEET 3 OF 13



	SHRUBS, ACCENTS, GROUNDCOVERS A	ND VINES SIZE
	SHRUBS	- OILL
	Bougainvillea x 'Torch Glow' TORCH GLOW BUSH BOUGAINVILLEA	5 GAL.
(•).	Caesalpinia mexicana MEXICAN BIRD-OF-PARADISE	15 GAL.
\bigcirc	Caesalpinia pulcherrima RED BIRD-OF-PARADISE	5 GAL.
	Calliandra californica RED BAJA FAIRY DUSTER	5 GAL.
•	Callistemon viminalis 'Little John' LITTLE JOHN BOTTLEBRUSH	5 GAL.
	Cassia artemisioides FEATHERY CASSIA	5 GAL.
	Cassia phyllodinea	5 GAL.
$((\bullet))$	SILVERY CASSIA Dodonaea viscosa 'Green'	5 GAL.
\bigcirc	GREEN HOPSEED BUSH Eremophila glabra carnosa	5 GAL.
⊕	WINTER BLAZE EMU BUSH Eremophila hygrophana 'Blue Bells'	5 GAL.
0	BLUE BELLS Eremophila maculata 'Valentine'	5 GAL.
90	VALENTINE BUSH Leucophyllum laevigatum	5 GAL.
<u></u> (9)	CHIHUAHUAN SÄGE Leucophyllum langmaniae 'Lynn's Legacy'	5 GAL.
8	LYNN'S LEGACY TEXAS SAGE Myrtus communis 'Compacta'	5 GAL.
(#)	DWARF MYRTLE Nandina domestica 'Nana'	5 GAL.
(b)	DWARF HEAVENLY BAMBOO Ruellia brittoniana	5 GAL
W A	BRITISH RUELLIA Ruellia penninsularis	5 GAL
\bowtie	DESERT RUELLIA	5 GAL
	Tecoma x 'Orange Jubilee' ORANGE JUBILEE YELLOW BELLS Tecomaria capensis	5 GAL
lacksquare	CAPE HONEYSUCKLE	J GAL.
Δ	ACCENTS Aloe striata	5 GAL.
*	CORAL ALOE Aloe X 'Blue Elf' BLUE ELF ALOE	3 GAL.
♥	Bouteloua gracilis	5 GAL.
*	BLUE GRAMA Hesperaloe funifera	5 GAL.
*	GIANT HESPERALOE Hesperaloe parviflora	5 GAL.
/\ ∰	RED YUCCA Hesperaloe parviflora 'Perpa'	5 GAL.
Ť	BRAKELIGHTS RED YUCCA Muhlenbergia capillaris	5 GAL
\$	'REGAL MIST'	5 GAL.
₩	Muhlenbergia emersleyi 'EL TORO' GRASS	5 GAL.
9	Muhlenbergia lindheimeri 'AUTUMN GLOW'	
470	Pedilanthus macrocarpus SLIPPER PLANT	5 GAL.
*	Yucca pallida PALE LEAF YUCCA	5 GAL.
(a)	Acacia redolens 'Desert Carpet' TM	1 GAL
	DESERT CARPET ACACIA	1 GAL.
₩ ®	Eremophila glabra 'Mingenew Gold' OUTBACK SUNRISE	1 GAL.
© @•	Lantana camara 'New Gold' NEW GOLD LANTANA Lantana montividensis	1 GAL.
G A	PURPLE TRAILING LANTANA Rosmarinus officinalis 'Prostratus'	1 GAL.
€	PROSTRATE ROSEMARY	
O	Wedelia trilobata YELLOW DOT	1 GAL.
	VINES Bougainvillea 'Barbara Karst'	5 GAL.
	Bougainvillea 'Barbara Karst' BARBARA KARST BOUGAINVILLEA	
	MISCELLANEOUS ITEM	SIZE
	Cynodon dactylon 'Midiron' BERMUDA GRASS	SOD
+ + + +	ROCK MULCH PALO VERDE BROWN GRANITE	1/2" SCREENED
	ARTIFICIAL TURF	
*** *********************************	4' WIDE DG TRAIL	1/4" MINUS

KEY MAP

CONCRETE HEADER

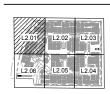

6" x 4"



04/06/2020

TB,RT

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LANDSCAPE PLAN

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GILBERT, ARIZONA

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PROJECT NO:

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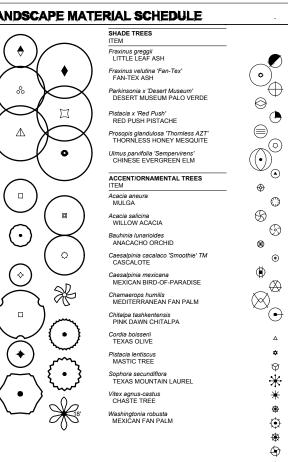
PLANTING PLAN

L2.01

SHEET 4 OF 13

MATCHLINE, SHEET L2.05

LANDSCAPE MATERIAL SCHEDULE




SHRUBS, ACCENTS, GROUNDCOVERS A ITEM	ND VINES SIZE
SHRUBS	
Bougainvillea x 'Torch Glow'	5 GAL.
TORCH GLOW BUSH BOUGAINVILLEA Caesalpinia mexicana	15 GAL.
MEXICAN BIRD-OF-PARADISE Caesalpinia pulcherrima	5 GAL.
RED BIRD-OF-PARADISE	
Calliandra californica RED BAJA FAIRY DUSTER	5 GAL.
Callistemon viminalis 'Little John'	5 GAL.
LITTLE JOHN BOTTLEBRUSH Cassia artemisioides	5 GAL.
FEATHERY CASSIA	5 GAL.
Cassia phyllodinea SILVERY CASSIA	
Dodonaea viscosa 'Green' GREEN HOPSEED BUSH	5 GAL.
Eremophila glabra carnosa WINTER BLAZE EMU BUSH	5 GAL.
WINTER BLAZE EMU BUSH	5 GAL.
Eremophila hygrophana 'Blue Bells' BLUE BELLS	
Eremophila maculata 'Valentine' VALENTINE BUSH	5 GAL.
Leucophyllum laevigatum	5 GAL.
CHIHUAHUAN SAGE Leucophyllum langmaniae 'Lynn's Legacy'	5 GAL.
I VNN'S I EGACY TEYAS SAGE	5 GAL
Myrtus communis 'Compacta' DWARF MYRTLE	0 0/12.
Nandina domestica 'Nana' DWARF HEAVENLY BAMBOO	5 GAL.
Ruellia brittoniana	5 GAL.
BRITISH RUELLIA Ruellia penninsularis	5 GAL
Ruellia penninsularis DESERT RUELLIA	
DESERT RUELLIA Tecoma x 'Orange Jubilee' ORANGE JUBILEE YELLOW BELLS Tecomaria canensis	5 GAL.
	5 GAL.
CAPE HONEYSUCKLE ACCENTS	
Aloe striata	5 GAL.
CORAL ALOF	3 GAL
Aloe X 'Blue Elf' BLUE ELF ALOE	
Bouteloua gracilis BLUE GRAMA	5 GAL.
Hesperaloe funifera	5 GAL.
GÍANT HESPERALOE Hesperaloe parviflora	5 GAL.
RED YUCCA	
Hesperaloe parviflora 'Perpa' BRAKELIGHTS RED YUCCA	5 GAL.
Muhlenbergia capillaris	5 GAL.
'REGAL MIST' Muhlenbergia emersleyi	5 GAL.
Muhlenbergia emersleyi 'EL TORO' GRASS Muhlenbergia lindha imagi	
Muhlenbergia lindheimeri 'AUTUMN GLOW'	5 GAL.
Pedilanthus macrocarpus SLIPPER PLANT	5 GAL.
Yucca pallida	5 GAL.
PALE LEAF YUCCA	
GROUNDCOVERS Acacia redolens 'Desert Carpet' TM	1 GAL.
DESERT CARPET ACACIA	
Eremophila glabra 'Mingenew Gold' OUTBACK SUNRISE	1 GAL.
Lantana camara 'New Gold'	1 GAL.
NEW GOLD LANTANA Lantana montividensis	1 GAL.
PURPLE TRAILING LANTANA Rosmarinus officinalis 'Prostratus'	1 GAL.
PROSTRATE ROSEMARY	
Wedelia trilobata YELLOW DOT	1 GAL.
VINES	
Bougainvillea 'Barbara Karst'	5 GAL.
BARBARA KARST BOUGAINVILLEA	
MISCELLANEOUS TEM	SIZE
Cynodon dactylon 'Midiron' BERMUDA GRASS	SOD
ROCK MULCH PALO VERDE BROWN GRANITE	1/2" SCREENED
ARTIFICIAL TURF	
4' WIDE DG TRAIL	1/4" MINUS

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KEY MAP

CONCRETE HEADER



6" x 4"

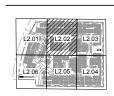

PROJECT NO 19001632 04/06/2020 DRAWN: TB,RT REVIEWED

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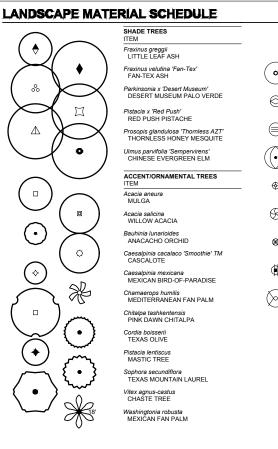
GILBERT, ARIZONA


PLANTING PLAN

L2.02

SHEET 5 OF 13

MATCHLINE, SHEET L2.04




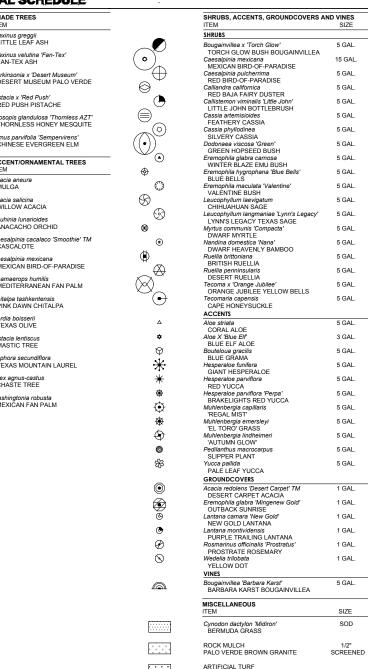

KEY MAP

4' WIDE DG TRAIL

CONCRETE HEADER

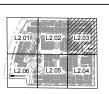

1/4" MINUS

6" x 4"



EXPIRES 03/31/20 LANDSCAP **PRELIMINARY** NOT FOR CONSTRUCTION



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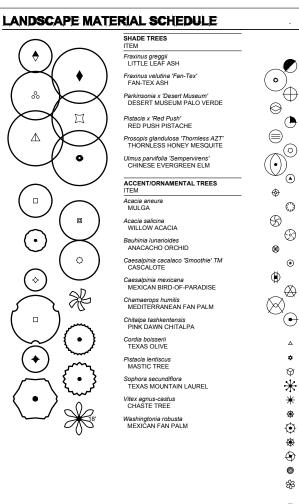
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PROJECT NO 19001632 04/06/2020 DRAWN: TB.RT REVIEWED

PLANTING PLAN

L2.03


SHEET 6 OF 13



	SHRUBS, ACCENTS, GROUNDCOVERS A	AND VINES SIZE
_	SHRUBS	
	Bougainvillea x 'Torch Glow' TORCH GLOW BUSH BOUGAINVILLEA	5 GAL.
)	Caesalpinia mexicana MEXICAN BIRD-OF-PARADISE	15 GAL.
\oplus	Caesalpinia pulcherrima RED BIRD-OF-PARADISE	5 GAL.
	Calliandra californica RED BAJA FAIRY DUSTER	5 GAL.
•	Callistemon viminalis 'Little John' LITTLE JOHN BOTTLEBRUSH	5 GAL.
_	Cassia artemisioides FEATHERY CASSIA	5 GAL.
②	Cassia phyllodinea	5 GAL.
)	SILVERY CASSIA Dodonaea viscosa 'Green'	5 GAL.
(●	GREEN HOPSEED BUSH Eremophila glabra carnosa	5 GAL.
	WINTER BLAZE EMU BUSH Eremophila hygrophana 'Blue Bells'	5 GAL.
	BLUE BELLS Eremophila maculata 'Valentine'	5 GAL.
Ψ	VALENTINE BUSH Leucophyllum laevigatum	5 GAL.
(F)	CHIHUAHUAN SAGE Leucophyllum langmaniae 'Lynn's Legacy'	5 GAL.
עש	LYNN'S LEGACY TEXAS SAGE	
•)	Myrtus communis 'Compacta' DWARF MYRTLE	5 GAL.
	Nandina domestica 'Nana' DWARF HEAVENLY BAMBOO	5 GAL.
	Ruellia brittoniana BRITISH RUELLIA	5 GAL.
	Ruellia penninsularis DESERT RUELLIA	5 GAL.
	Tecoma x 'Orange Jubilee'	5 GAL.
	ORANGE JUBILEE YELLOW BELLS Tecomaria capensis	5 GAL.
	CAPE HONEYSUCKLE ACCENTS	
	Aloe striata	5 GAL.
	CORAL ALOE Aloe X 'Blue Elf'	3 GAL.
	BLUE ELF ALOE Bouteloua gracilis	5 GAL.
	BLUE GRAMA Hesperaloe funifera	5 GAL.
	GIANT HESPERALOE	
	Hesperaloe parviflora RED YUCCA	5 GAL.
	Hesperaloe parviflora 'Perpa' BRAKELIGHTS RED YUCCA	5 GAL.
	Muhlenbergia capillaris 'REGAL MIST'	5 GAL.
	Muhlenbergia emersleyi 'EL TORO' GRASS	5 GAL.
	Muhlenbergia lindheimeri	5 GAL.
	'AUTUMN GLOW' Pedilanthus macrocarpus	5 GAL.
	SLIPPER PLANT Yucca pallida	5 GAL.
	PALE LEAF YUCCA GROUNDCOVERS	
	Acacia redolens 'Desert Carpet' TM	1 GAL.
	DESERT CARPET ACACIA Eremophila glabra 'Mingenew Gold'	1 GAL.
	OUTBACK SUNRISE Lantana camara 'New Gold'	1 GAL.
	NEW GOLD LANTANA Lantana montividensis	1 GAL.
	PURPLE TRAILING LANTANA	
	Rosmarinus officinalis 'Prostratus' PROSTRATE ROSEMARY	1 GAL.
	Wedelia trilobata YELLOW DOT	1 GAL.
	VINES	F.C.**
	Bougainvillea 'Barbara Karst' BARBARA KARST BOUGAINVILLEA	5 GAL.
	MISCELLANEOUS ITEM	SIZE
	Cynodon dactylon 'Midiron' BERMUDA GRASS	SOD
-	ROCK MULCH PALO VERDE BROWN GRANITE	1/2" SCREENED
•;	ARTIFICIAL TURF	
	4' WIDE DG TRAIL	1/4" MINUS

KEY MAP

CONCRETE HEADER

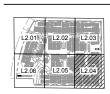



6" x 4"

19001632 04/06/2020

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PRELIMINARY

NOT FOR

CONSTRUCTION

VP/SONA U.S

Contact Arizona 811 at least two full working days before you begin excavation

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PLAN

LANDSCAPE

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PROJECT NO:


DRAWN:

REVIEWED

PLANTING PLAN

L2.04

SHEET 7 OF 13

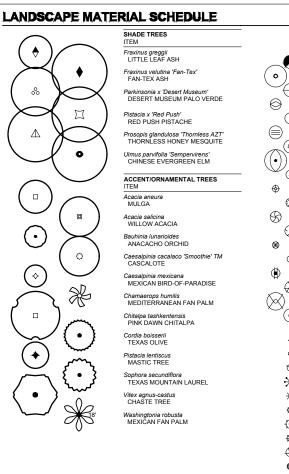

SHRUBS, ACCENTS, GROUNDCOVERS	AND VINES SIZE
SHRUBS	
Bougainvillea x 'Torch Glow' TORCH GLOW BUSH BOUGAINVILLEA	5 GAL.
Caesalpinia mexicana	15 GAL.
MEXICAN BIRD-OF-PARADISE	5 GAL
Caesalpinia pulcherrima RED BIRD-OF-PARADISE	
Calliandra californica RED BAJA FAIRY DUSTER	5 GAL.
Callistemon viminalis 'Little John'	5 GAL.
LITTLE JOHN BOTTLEBRUSH Cassia artemisioides	5 GAL.
FEATHERY CASSIA	5 GAL.
Cassia phyllodinea	5 GAL.
SILVERY CASSIA Dodonaea viscosa 'Green'	5 GAL.
GREEN HOPSEED BUSH	
Eremophila glabra carnosa WINTER BLAZE EMU BUSH	5 GAL.
Eremophila hygrophana 'Blue Bells' BLUE BELLS	5 GAL.
BLUE BELLS Eremophila maculata 'Valentine'	5 GAL
VALENTINE BUSH	
Leucophyllum laevigatum CHIHUAHUAN SAGE	5 GAL.
Leucophyllum langmaniae 'Lynn's Legacy'	5 GAL.
LYNN'S LEGACY TEXAS SAGE	
Myrtus communis 'Compacta' DWARF MYRTLE	5 GAL.
Nandina domestica 'Nana'	5 GAL.
DWARF HEAVENLY BAMBOO Ruellia brittoniana	5 GAL
BRITISH RUELLIA	
Ruellia penninsularis DESERT RUELLIA	5 GAL.
Tecoma x 'Orange Jubilee' ORANGE JUBILEE YELLOW BELLS	5 GAL.
ORANGE JUBİLEE YELLOW BELLS Tecomaria capensis	5 GAL
CAPE HONEYSUCKLE	5 GAL.
ACCENTS	
Aloe striata CORAL ALOE	5 GAL.
Aloe X 'Blue Elf' BLUE ELF ALOE	3 GAL.
BLUE ELF ALOE	
Bouteloua gracilis BLUE GRAMA	5 GAL.
Hesperaloe funifera	5 GAL.
GIANT HESPERALOE Hesperaloe parviflora	5 GAL
Hesperaloe parviflora RED YUCCA	
Hesperaloe parviflora 'Perpa' BRAKELIGHTS RED YUCCA	5 GAL.
Muhlenbergia capillaris	5 GAL.
'REGAL MIST'	5 GAL.
Muhlenbergia emersleyi 'EL TORO' GRASS	
Muhlenbergia lindheimeri	5 GAL.
'AUTUMN GLOW' Pedilanthus macrocarpus	5 GAL.
SLIPPER PLANT	
Yucca pallida PALE LEAF YUCCA	5 GAL.
GROUNDCOVERS	
Acacia redolens 'Desert Carpet' TM	1 GAL.
DESERT CARPET ACACIA Eremophila glabra 'Mingenew Gold'	1 GAL.
OUTBACK SUNRISE	
Lantana camara 'New Gold' NEW GOLD LANTANA	1 GAL.
Lantana montividensis	1 GAL.
PURPLE TRAILING LANTANA Rosmarinus officinalis 'Prostratus'	1 GAL.
PROSTRATE ROSEMARY	
Wedelia trilobata	1 GAL.
YELLOW DOT VINES	
Bougainvillea 'Barbara Karst'	5 GAL.
BARBARA KARST BOUGAINVILLEA	5 5, iL.
MISCELLANEOUS ITEM	SIZE
Cynodon dactylon 'Midiron'	SOD
BERMUDA GRASS	
ROCK MULCH	1/2"
PALO VERDE BROWN GRANITE	SCREENE
ADTICION TUDE	
ARTIFICIAL TURF	
ARTIFICIAL TURF 4' WIDE DG TRAIL	1/4" MINUS

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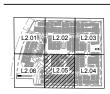
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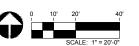
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KEY MAP

CONCRETE HEADER





PROJECT NO: 19001632 04/06/2020 DRAWN: TB.RT REVIEWED

LANDSCAPE

PRELIMINARY

NOT FOR

CONSTRUCTION

VP/SONA U.S

Contact Arizona 811 at least two full working days before you begin excavation

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PLAN

LANDSCAPE

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GILBERT, ARIZONA

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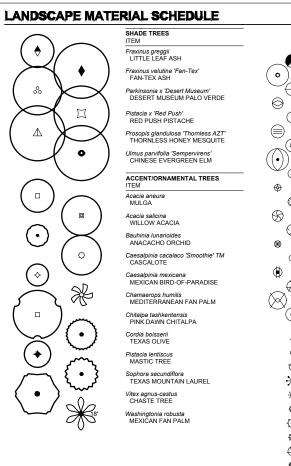
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6" x 4"

PLANTING PLAN

L2.05

SHEET 8 OF 13



SHRUBS, ACCENTS, GROUNDCOVERS A	AND VINE
SHRUBS	
Bougainvillea x 'Torch Glow'	5 GA
TORCH GLOW BUSH BOUGAINVILLEA Caesalpinia mexicana	15 GA
MEXICAN BIRD-OF-PARADISE	
Caesalpinia pulcherrima	5 GA
RED BIRD-OF-PARADISE Calliandra californica	5 GA
RED BAJA FAIRY DUSTER	
Callistemon viminalis 'Little John'	5 GA
LITTLE JOHN BOTTLEBRUSH Cassia artemisioides	5 GA
FEATHERY CASSIA	
Cassia phyllodinea SILVERY CASSIA	5 GA
Dodonaea viscosa 'Green'	5 GA
GREEN HOPSEED BUSH	
Eremophila glabra carnosa WINTER BLAZE EMU BUSH	5 GA
Eremophila hygrophana 'Blue Bells'	5 GA
BLUE BELLS	5.04
Eremophila maculata 'Valentine' VALENTINE BUSH	5 GA
Leucophyllum laevigatum	5 GA
CHIHUAHUAN SAGE	E C ^
Leucophyllum langmaniae 'Lynn's Legacy' LYNN'S LEGACY TEXAS SAGE	5 GA
Myrtus communis 'Compacta'	5 GA
DWARF MYRTLE	5 GA
Nandina domestica 'Nana' DWARF HEAVENLY BAMBOO	5 GA
Ruellia brittoniana	5 GA
BRITISH RUELLIA Ruellia penninsularis	5 GA
DESERT RUELLIA	3 GA
Tecoma x 'Orange Jubilee'	5 GA
ORANGE JUBILEE YELLOW BELLS Tecomaria capensis	5 GA
CAPE HONEYSUCKLE	3 07
ACCENTS	
Aloe striata	5 GA
CORAL ALOE Aloe X 'Blue Elf'	3 GA
BLUE ELF ALOE	
Bouteloua gracilis	5 GA
BLUE GRAMA Hesperaloe funifera	5 GA
GIANT HESPERALOE	
Hesperaloe parviflora RED YUCCA	5 GA
Hesperaloe parviflora 'Perpa'	5 GA
BRAKELIGHTS RED YUCCA	
Muhlenbergia capillaris 'REGAL MIST'	5 GA
Muhlenbergia emerslevi	5 GA
'EL TORO' GRASS	
Muhlenbergia lindheimeri 'AUTUMN GLOW'	5 GA
Pedilanthus macrocarpus	5 GA
SLIPPER PLANT	F 0.4
Yucca pallida PALE LEAF YUCCA	5 GA
GROUNDCOVERS	
Acacia redolens 'Desert Carpet' TM	1 GA
DESERT CARPET ACACÍA Eremophila glabra 'Mingenew Gold'	
OUTBACK SUNRISE	1 GA
Lantana camara 'New Gold'	1 GA
NEW GOLD LANTANA	4.04
Lantana montividensis PURPLE TRAILING LANTANA	1 GA
Rosmarinus officinalis 'Prostratus'	1 GA
PROSTRATE ROSEMARY Wedelia trilobata	1 GA
YELLOW DOT	1 0/
VINES	
Bougainvillea 'Barbara Karst'	5 GA
BARBARA KARST BOUGAINVILLEA	
MISCELLANEOUS ITEM	SIZE
Cynodon dactylon 'Midiron' BERMUDA GRASS	SOI
	4/01
ROCK MULCH PALO VERDE BROWN GRANITE	1/2' SCREE
	JUNE
ARTIFICIAL TURF	
4' WIDE DG TRAIL	1/4" MI
WIDE DO TRAIL	1/4 IVIII

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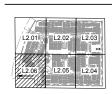
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KEY MAP

CONCRETE HEADER





6" x 4"

DRAWN: TB,RT REVIEWED

19001632 04/06/2020

PROJECT NO:

PRELIMINARY

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CONSTRUCTION

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LANDSCAPE PLAN

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GILBERT, ARIZONA

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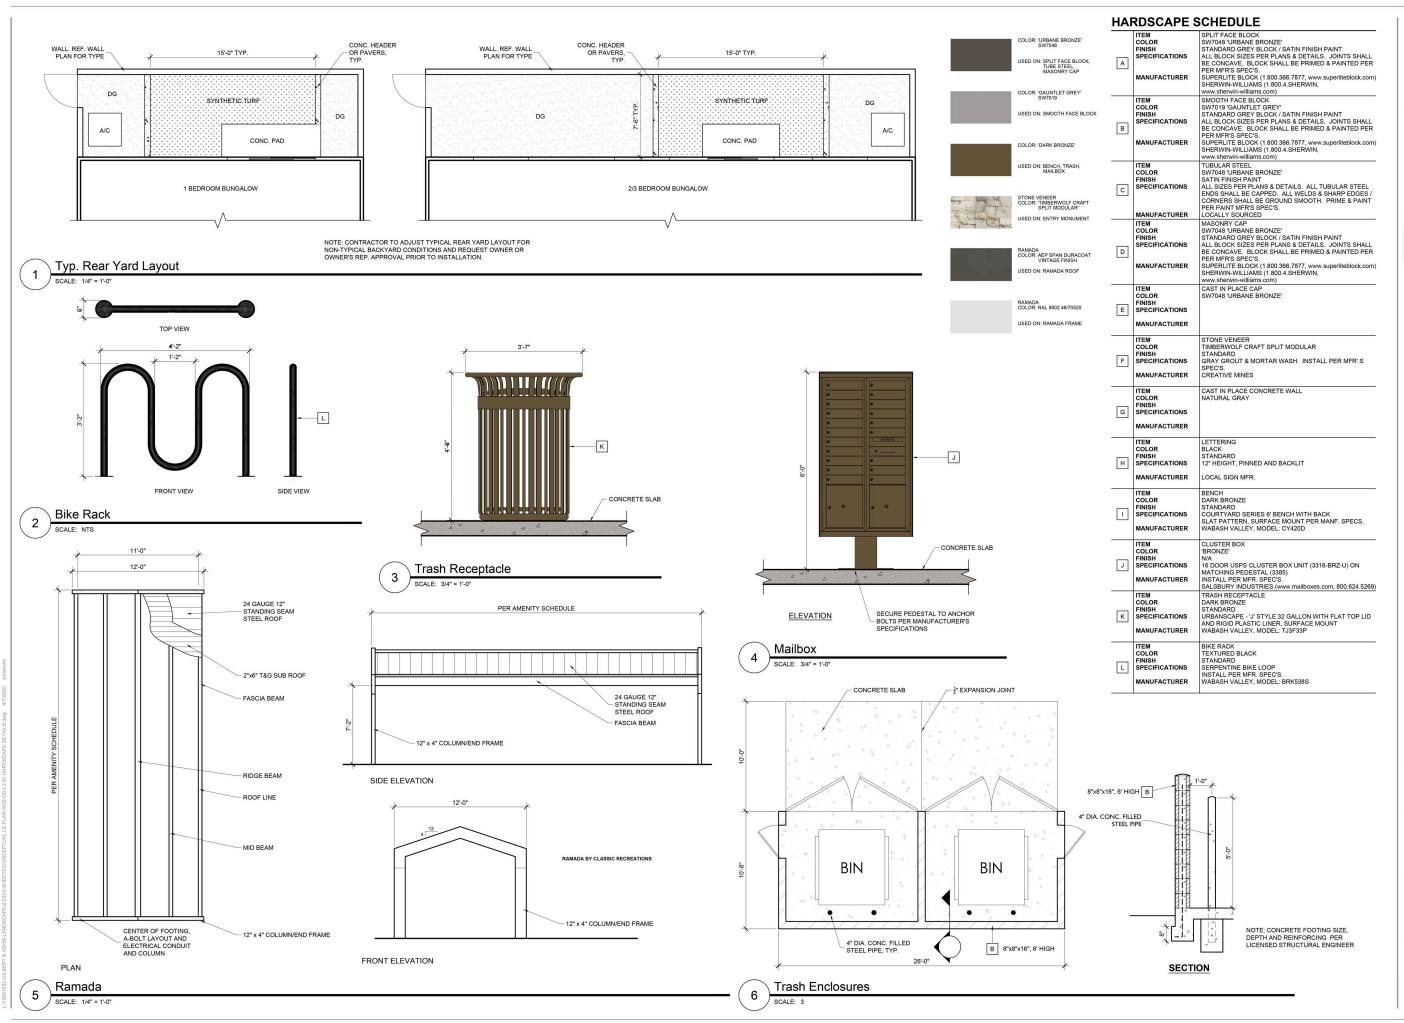
.OWS

BUNGAL

PLANTING PLAN

L2.06

SHEET 9 OF 13



120 S. Ash Avenue Tempe, Arizona 85281 Tel: 480.994.0994 www.violanning.com

EXPIRES 03/31/20

PRELIMINARY NOT FOR CONSTRUCTION



'HE BUNGALOWS ON ASH CONCEPTUAL LANDSCAPE PLAN GILBERT, ARIZONA

PROJECT NO: 19001632

DATE: 04/06/2020

DRAWN: TB,RT
REVIEWED: MR


REVISIONS

A
A
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B

HARDSCAPE DETAILS

_3.02

SHEET 13 OF 13

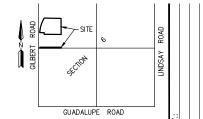

VICINITY MAP

PLAN

DRAINAGE

AND

GRADING

PRELIMINARY

OWNER/DEVELOPER ADVANCED ACQUISITIONS, LLC 15300 N. 90TH ST., SUITE 200 SCOTTSDALE, AZ 85260

ARCHITECT

RVI PLANNING AND

LANDSCAPE ARCHITECTURE
120 SOUTH ASH AVENUE TEMPE. AZ 85281 PH: (480) 944-0994 CONTACT: MARK REDDIE

ENGINEER

HILGARTWILSON, LLC 2141 E. HIGHLAND AVENUE, SUITE 250 PHOENIX, ARIZONA 85016 PHONE: (602) 490-0535 FAX: (602) 368-2436 CONTACT: SCOTT ODYA

BASIS OF BEARING

THE BASIS OF BEARING IS NOO'33'53"W
ALONG THE EAST LINE OF THE NORTHWEST
QUARTER OF SECTION 6, TOWNSHIP 1
SOUTH, RANGE 6 EAST OF THE GILA AND SALT RIVER MERIDIAN, MARICOPA COUNTY, ARIZONA,

BENCHMARK

BENCHMARK IS FOUND 3" MARICOPA COUNTY HIGHWAY DEPARTMENT BRASS CAP IN HAND HOLF DOWN 1.2' LOCATED AT THE INTERSECTION OF BASELINE ROAD & GILBERT ROAD. FLEVATION: 1233 10'

FLOOD ZONE DESIGNATION

THE SUBJECT PROPERTY LIES WITHIN SHADED ZONE "X" WITH A DEFINITION OF: AREAS OF 0.2% ANNUAL CHANCE FLOOD: AREAS OF 1% ANNUAL CHANCE FLOOD WITH AVERAGE DEPTHS OF LESS THAN 1 FOOT OR WITH DRAINAGE AREAS LESS THAN 1 SQUARE MILE; AND AREAS PROTECTED BY LEVEES FROM 1% ANNUAL CHANCE FLOOD. DESIGNATION DETERMINED BY FEMA FLOOD ZONE MAP 04013CC2270M & 04013C2731M. PANEL NUMBER 2270 & 2731 OF 4425, EFFECTIVE DATE NOVEMBER 4, 2015.

SITE AREA (NET)

NET AREA= 685,700 SQ. FT. / 15.7415 AC


RETENTION CALCULATIONS

WHERE: OFF-1 C = 0.84 P = 3.0 IN. A = 646,797 S.F. C = 0.90 P = 3.0 IN A = 46,509 S.F.THEREFORE: VR = 145,830 C.F VP = 149,337 C.F

LEGEND

VR = C(P/12)A

	- PROPERTY LINE		CATCH BASIN(S)
	- CENTER LINE - EASEMENT LINE	SD	STORM DRAIN PIPE
FF=17.10	FINISH FLOOR ELEV	•	ACCESS MANHOLE
-	FLOW ARROWS		─8" MAIN SEWER LINE
-	EX. FLOW ARROWS	—— 8"W —	-8" MAIN WATER LINE
(1316)	EX. CONTOURS	1"W	-1" WATER LINE
— 1316 ——	- PROP. CONTOUR	•	FIRE HYDRANT (FH)
	DRAINAGE AREA	8	WATER VALVE
(DA-1)	DRAINAGE AREA LABEL		WATER METER
<u>U</u>		00	BACKFLOW PREVENTER (BFP)
	DRYWELL	/S	SEWER MANHOLE (MH)
—	DIVINEEL	/ e	SEWER CLEANOUT (CO)

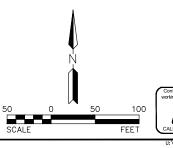



PGD-1

P



GILBERT, ARIZONA

THE BUNGALOWS ONE BEDROOM FRONT ENTRANCE







BM Black #2132-10

BM Chantilly Lace #2121-70

BM Light Pewter #1464





Raincloud Warehouse Brick


THE BUNGALOWS TWO BEDROOM





BM Chantilly Lace #2121-70

BM Light Pewter #1464

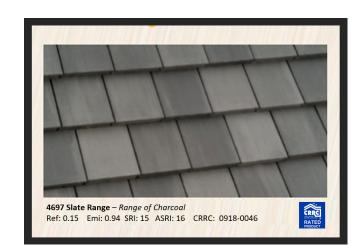



BM Winter Solstice #1605

THE BEDROOM





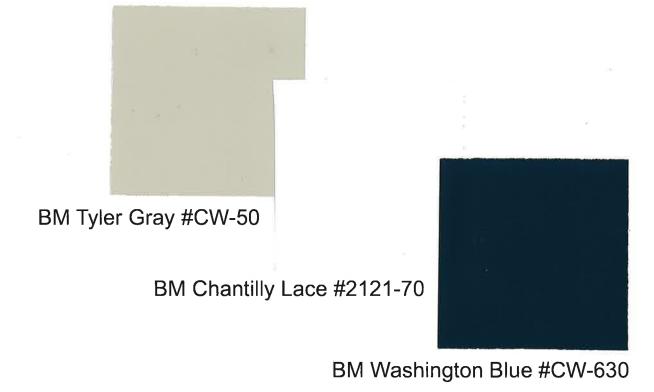

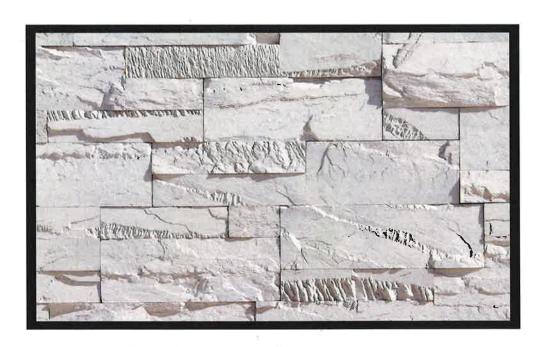


Lunar Craft Split Modular


THE BUNGALOWS GARAGE





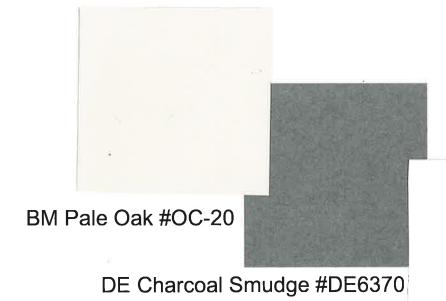



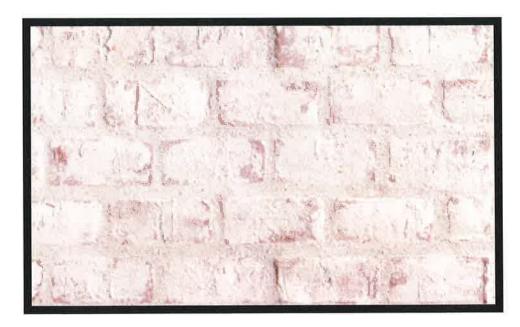

Craft Cannery Brick- Ghosted- Creative Mines

THE BUNGALOWS CLUBHOUSE









BM Chantilly Lace #2121-70

Craft Cannery Brick- Ghosted- Creative Mines

Specification Sheet




Board and Batten

Vinyl Siding

General Description: CertainTeed Board and Batten Siding provides the rustic look of alternating wide and narrow cedar board vertical siding, but does not require the upkeep common to wood. Board and Batten siding is appropriate for use in new construction for single family homes, multi-housing projects and light commercial developments. Board and Batten is also an ideal product for remodeling.

Styles:

Profile	Finish	Panel Projection	Wall Thickness (Nominal)	Lock Design	Colors	Accessory Pocket	Length
Single 8" Vertical	Rough Cedar	1/5"	.048"	DuraLock TM post- formed positive lock	11	1/2"	10' and 12'6"

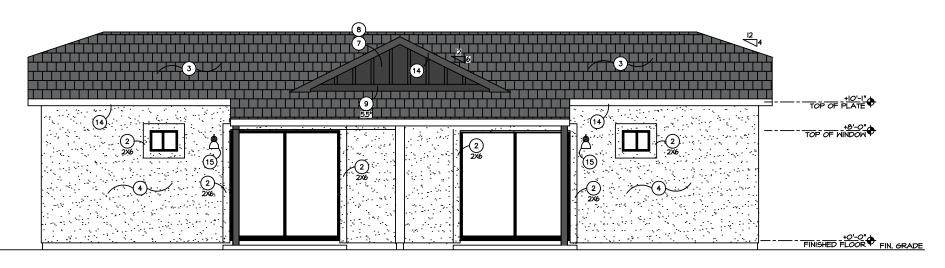


DR19-143 Bungalows on Ash Attachment 8 - Elevations

SPANISH LACE FINISH STUCCO POP-OUT - SIZE AS INDICATED CONCRETE TILE ROOF PER SPECS - VERIFY STYLE AND COLOR

BOARD & BATTEN STYLE VINYL SHUTTER

COLOR & MATERIALS TABLE					
KEYNOTE	MATERIAL				
1	BRICK VENEER	CREATIVE MINES - GHOSTED CRAFT CANNERY BRICK W/ BLACK GROUT			
3	ROOF TILE	EAGLE - SIERRA MADRE 4503			
4	MAIN BODY STUCCO	S.W PURE WHITE 7005			
5	MAIN BODY STUCCO	B.M PALE OAK OC20			
6	STUCCO WINDOW TRIM	S.W PURE WHITE 7005			
7 & 8	BOARD & BATTEN	S.W PURE WHITE 7005			
14	FASCIA BOARD	S.W BLACK MAGIC SW6991			
18	SHUTTERS	S.W BLACK MAGIC SW6991			
19	DOOR	S.W BLACK MAGIC SW6991			

REAR ELEVATION

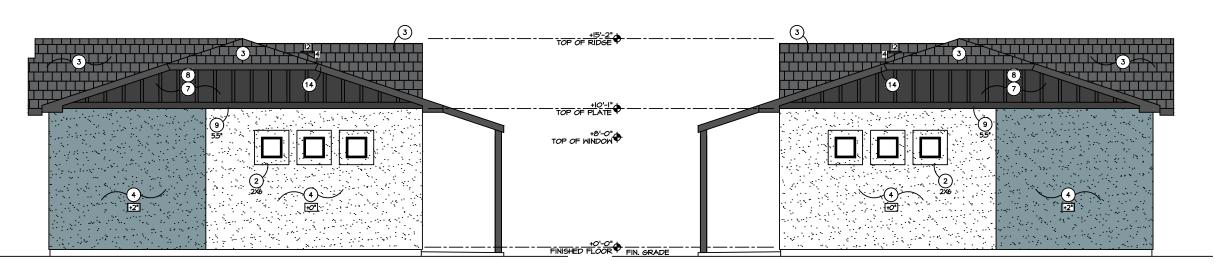


RIGHT ELEVATION

LEFT ELEVATION



40 **C**° Ow **BID SET** NOT FOR CONSTRUCTION BUNGALOWS ON ASH Gilbert, Arizona CAVAN PROPERTIES PROJECT NO.: 10900a CAD FILE: 10900A-EXHIBIT-COLOR DRAWN BY: 200221 CHECKED BY: D.C. SCALE: AS NOTED 1-BEDROOM FRONT ENTRY 1BFE

FRONT ELEVATION

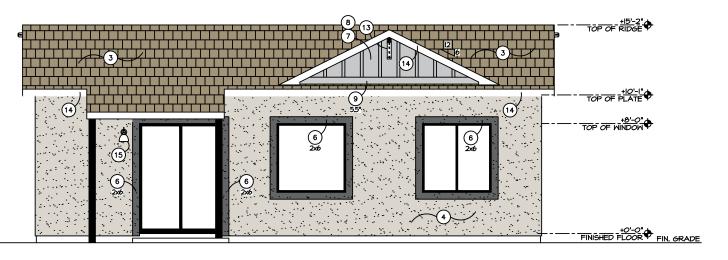

REAR ELEVATION


SCALE = N.T.S.

ELEVATION KEYNOTES

PANISH LACE FINISH STUCCO POP-OUT - SIZE AS INDICATED CONCRETE TILE ROOF PER SPECS - VERIFY STYLE AND COLOR PANISH LACE FINISH STUCCO - VERIFY WITH SPECS

COLOR & MATERIALS TABLE			
KEYNOTE	MATERIAL	BRAND / COLOR	
3	ROOF TILE	EAGLE - SLATE RANGE 297	
5	MAIN BODY STUCCO	B.M LIGHT PEWTER 1464	
6	STUCCO WINDOW TRIM	B.M LEAD GRAY 2131-30	
7 & 8	BOARD & BATTEN	B.M WINTER SOLSTICE 1605	
13 & 14	FASCIA BOARD	B.M CHANTILLY LACE 2121-70	

18 DOOR S.W. - DUTCH TILE BLUE SW0031

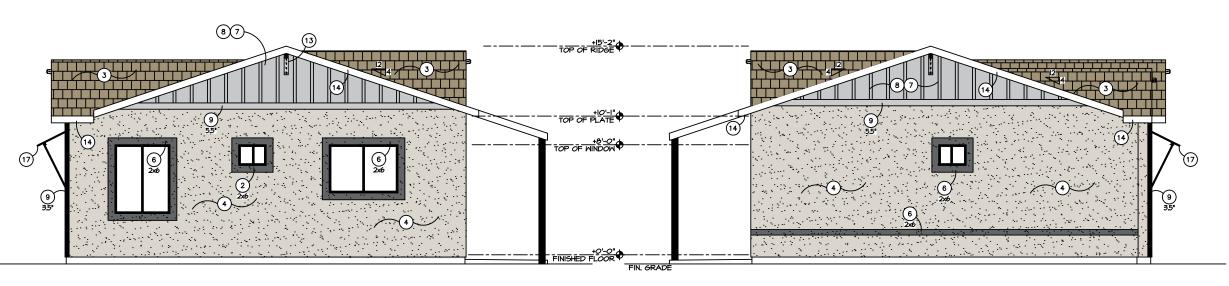


RIGHT ELEVATION

SCALE = N.T.S.

LEFT ELEVATION

SCALE = N.T.S.

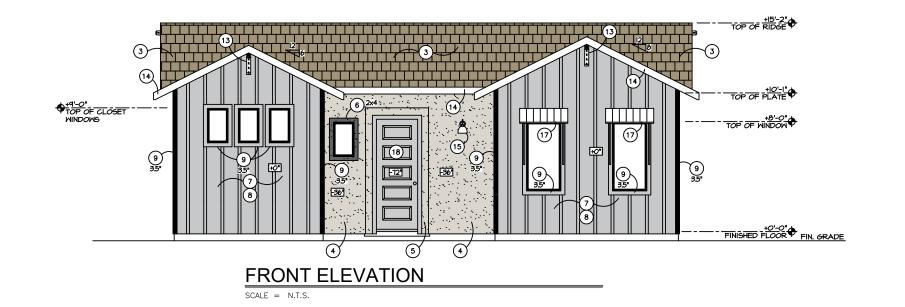

40 ۰**۵**° တ **O** < ± **BID SET** NOT FOR CONSTRUCTION BUNGALOWS ON ASH Gilbert, Arizona CAVAN PROPERTIES PROJECT NO.: 10900a CAD FILE: 10900A-EXHIBIT-COLOR

DRAWN BY: 0.2.

CHECKED BY: D.C. SCALE: AS NOTED

2-BEDROOM

2B

REAR ELEVATION

SCALE = 1/4"=1'-0"


ELEVATION KEYNOTES

PANISH LACE FINISH STUCCO POP-OUT - SIZE AS INDICATED CONCRETE TILE ROOF PER SPECS - VERIFY STYLE AND COLOR PANISH LACE FINISH STUCCO - VERIFY WITH SPECS SAND FINISH STUCCO - VERIFY WITH SPECS anel vertical siding (or similar); verify finish — esr—229

COLOR & MATERIALS TABLE			
KEYNOTE	MATERIAL		
1	CULTURED STONE	CREATIVE MINES - BLACK TRUFFLE CRAFT SPLIT MODULAR	
3	ROOF TILE	EAGLE - SLATE RANGE 297	
5	MAIN BODY STUCCO	B.M CARTER GRAY CW-80	
_			

BOARD & BATTEN

B.M. - CHANTILLY LACE 2121-70 B.M. - CHANTILLY LACE 2121-70

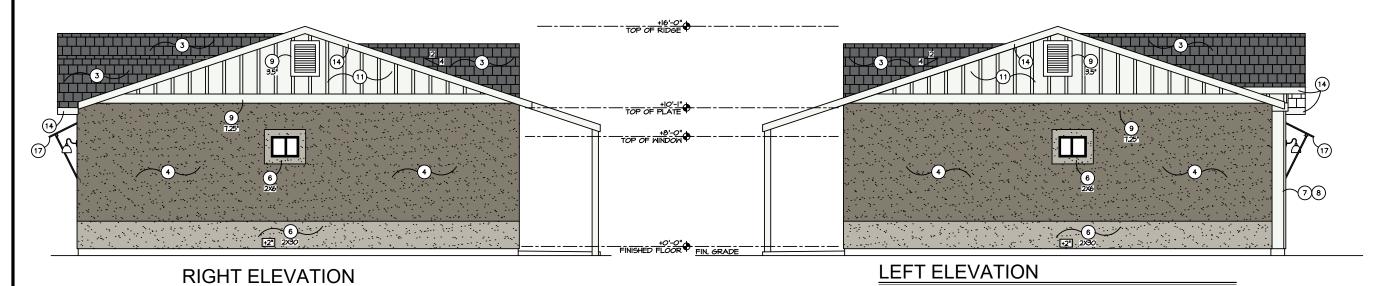

SCALE = 1/4"=1'-0"



FRONT ELEVATION

SCALE = 1/4"=1'-0"

40 CO Suite တ Ow **O** < ± **2** 8 8 4 5 7 8 4 5 7 8 **BID SET** NOT FOR CONSTRUCTION BUNGALOWS ON ASH Gilbert, Arizona CAVAN PROPERTIES PROJECT NO.: 10900a DRAWN BY: 0.2.

CAD FILE: 10900A-EXHIBIT-COLOR CHECKED BY: D.C.

SCALE: AS NOTED

3-BEDROOM

3B

SCALE = 1/4"=1'-0"

ELEVATION KEYNOTES

1) BRICK VENEER - VERIFY STYLE AND COLOR 2) STEEL DOOR

CONCRETE TILE ROOF PER SPECS – VERIFY STYLE A
 ARCHITECTURAL GARAGE DOOR

5 LACE FINISH STUCCO - VERIFY WITH SPI

7 HARDIEPANEL VERTICAL SIDING (OR SIMILAR); VERIFY FINISH — ESR-

10 NOT USED


11) NOT USED

14) SMOOTH FINISH FASCIA PER DETAI

15 SCONCE • +90" TO CENTER - SEE SPECIFICATIONS FOR STY


REAR ELEVATION

SCALE = N.T.S.

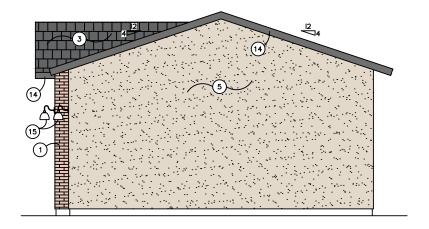


RIGHT ELEVATION

SCALE = N.T.S.

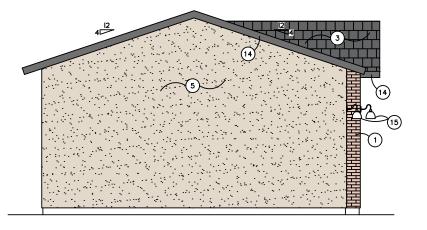


LEFT ELEVATION

CALE = N.T.S.

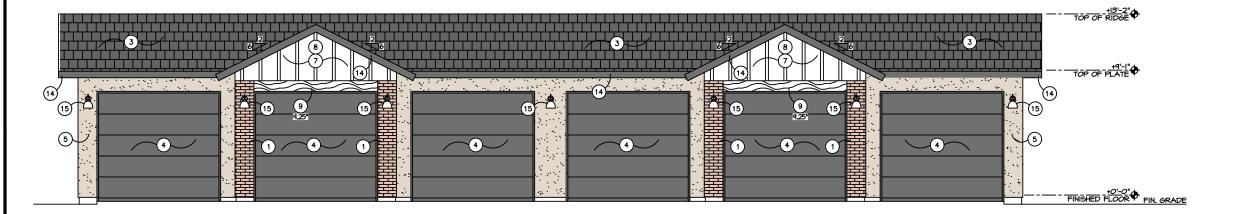



FRONT ELEVATION


SCALE = N.T.S.

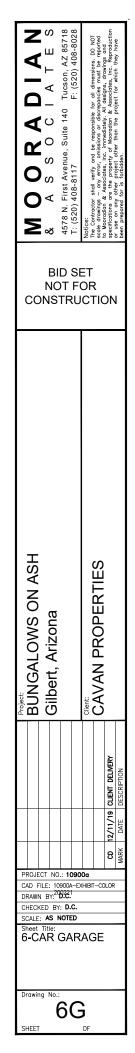

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SCALE = 1/4"=1'-0"

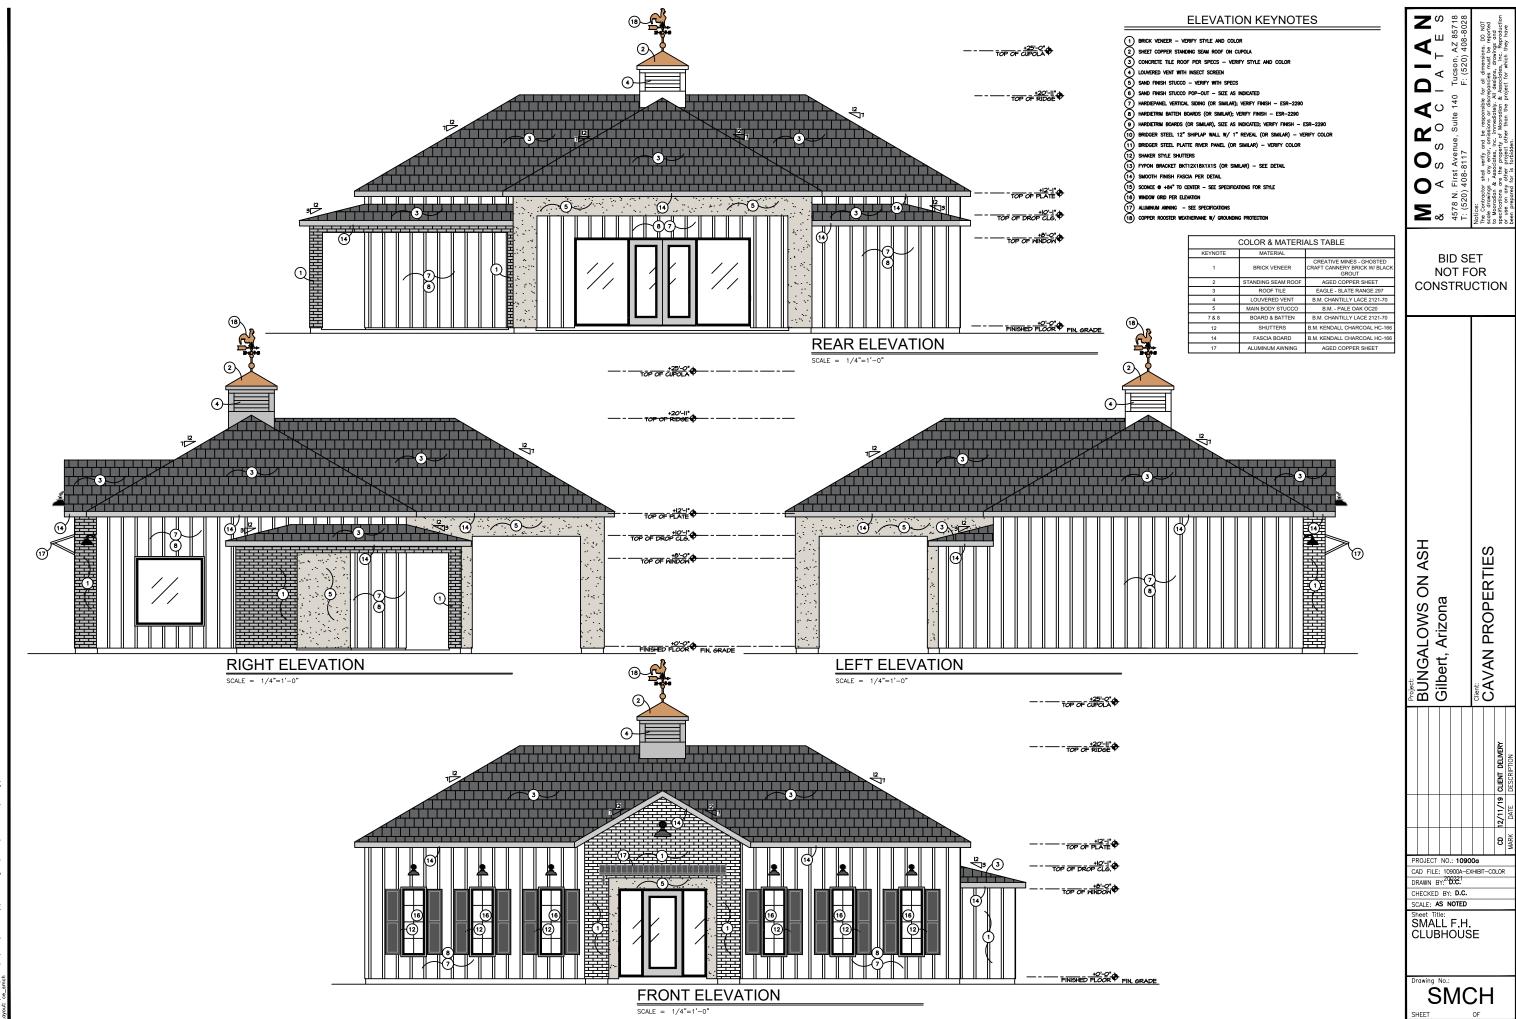1-BDRM DUPLEX

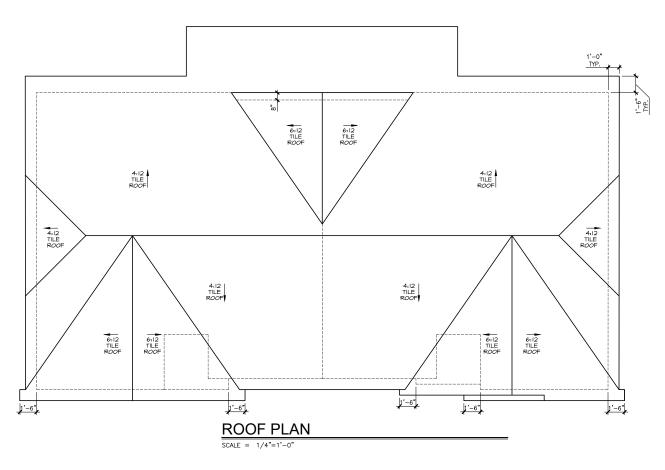FLOOR PLAN NOTES

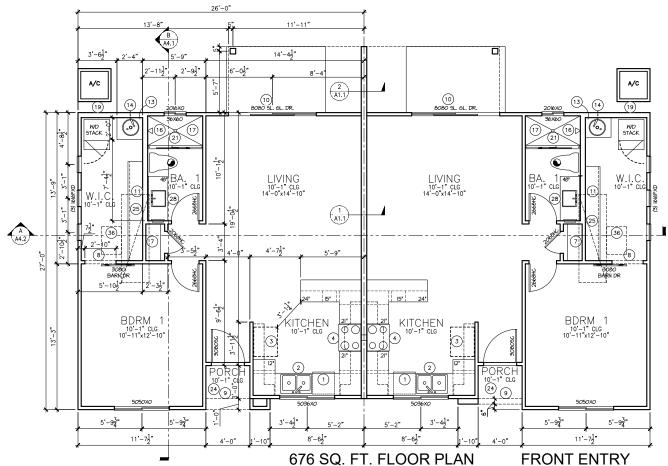DR19-143 Bungalows on Ash ⊗ FLOOR PLAN K Attachment 9 - Floor Plans DISHWASHER - SEE BUYERS SELECTION SH

- 1. ALL WINDOW HEADER HEIGHTS ARE AT 8"-0", U.NO.
 2. ALL PENETRATIONS THROUGH THE SEPARATION BETWEEN CARAGE AND LIVABLE AREA MUST BE PROTECTED BY PILLING THE OPEN AREA AROUND THE PENETRATION WITH AN APPROVED MATERIAL TO RESIST FREE PASSAGE OF FLAME AND OTHER PRODUCTS OF COMBUSTION PER SECTION R302.5, 2012 I.R.C. "SEMCO PR-855" CAULKING OR COUAL (UL CLASSIFED 814-6) (ASTM E84 CLASS A: FLAME SPREAD NO. 25)
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 TO ACHIEVE PROPER INSULATION INSTALLATION, PROVIDE HORIZ, AND/OR VERT, AIR BARRIER (O.S.B., CYP. BD. OR EQ.) AT MAIN ATTIC LINE (BOT. CHORD OF TRUSS), KHEE WALLS, CAPS, ETC.
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- 8. ALL QUAD PANEL STACKING DOORS (16'-0" OR 20'-0") REQUIRE 8" MIN. WALL
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 COXCITO OR RANGE WI POHAUST HOLD SEE BUSIES SELECTION SHEET

 8°W. X 8°H. RECESS ® +6" A.F.F. FOR CAS STUB (WHERE APPLICABLE)

 5. OHN AND MICROWAVE OR DOUBLE OWN! LOCATION SEE BUSIES SELECTION SHEET

 8°W. X 9°H. RECESS ® +6" A.F.F. FOR CAS STUB (WHERE APPLICABLE)

 6. PARITY FROME BLOCKING AND INSTALL SHELMING FER BULIDERS SPECIFICATIONS

 7. LINEN FROMDE BLOCKING AND INSTALL SHELMING FER BULIDERS SPECIFICATIONS

 8. DROPPED INTERIOR SOFTIT 12" DOWN FROM LOWEST ADJACENT CBUING, U.N.O.

 9. EXTEROR STUCCO WARPED SOFTIT SEE ELEVATIONS FOR HEIGHT

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 12. GRANGE TO HOUSE DOOR SHALL BE 1 3/8" SOUD CORE OR 20 MIN. FIRE RATED AND

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KITCHEN SINK W/ DISPOSAL — SEE BLYER
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 19. 256 WALL FOR WASHER BOX AND 14 1/2"W. X 12"H. RECESS @ +6" A.F.F. FOR DRYER

 VENT (AND GAS STUB WHERE APPLUABLE)

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- VENT (MOL GAS SILES WHENE APPLICABLE)

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 23. ZX KNEE WALL HEIGHT AS NOTED OR +34 1/2" AT FLUSH KITCHEN COUNTER CONDITION

 24. 1/2" SAG RESISTANT EXTERIOR GYPSUM SOFFIT BOARD (ESR #1338)

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 26. SLOBES STOODS SHELED ON DESTINE DEWANGE MIN. 1" DLE (REPOINTE THERMO-DELASTIC)
- 26. SLOPE STUCCO SHELF FOR POSITIVE DRAINAGE, MIN. 1" P.L.F. (PROVIDE THERMO-PLASTIC
- WATERPROOFING MEMBRANE OR EQUAL UNDER STUCCO)

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- 30. LPPER CABNETS

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 34. 2X6 GARAGE DOOR BUCK, BOTTOM TO TERMINATE AT TOP OF STEM

 35. OPERABLE PARTS FOR INACTIVE LEAF OF DOUBLE DOOR SHALL NOT BE HIGHER THAN

 48" A.F.F.

 36. 22"x32" ATTIC ACCESS 30" MIN. HEADROOM AT 4:12 PITCHED ROOF ONLY; SEE DETAIL


 37. MECHANOL UNI LOCATION ON 18" HIGH PLAIFORM PROTECTED FROM VEHICLE IMPACT WHEN


 REQUIRED AT FLAT ROOF ELEVATION


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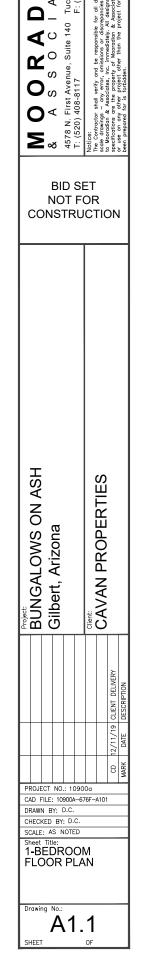
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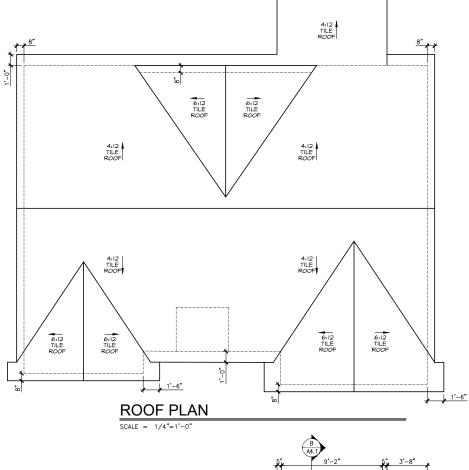







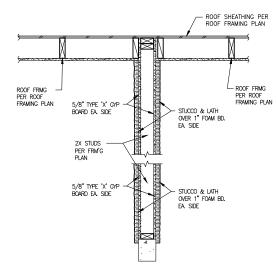

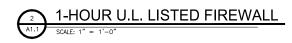

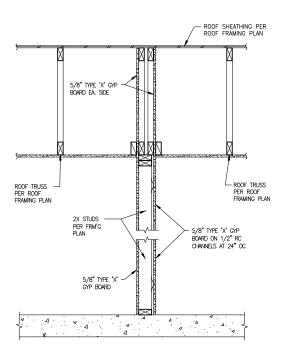

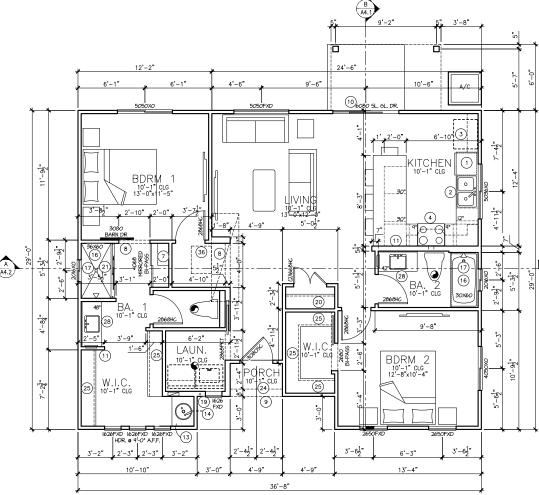

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S S 85718 **∠**" ⋖∘ တ Oo **O**∢ ± 78 N. & 4578 T: (5 **BID SET**

NOT FOR CONSTRUCTION

PROPERTIE BUNGALOWS O Gilbert, Arizona CAVAN

ASH

NO O

CAD_FILE: 10900A-1012-A101

PROJECT NO.: 10900a

DRAWN RY: D.C. CHECKED BY: D.C.

SCALE: AS NOTED 2-BEDROOM

Drawina No. A1.1

FLOOR PLAN

1012 SQ. FT. FLOOR PLAN

SCALE = 1/4"=1'-0"

2-BDRM SFH

1355 SQ. FT. FLOOR PLAN

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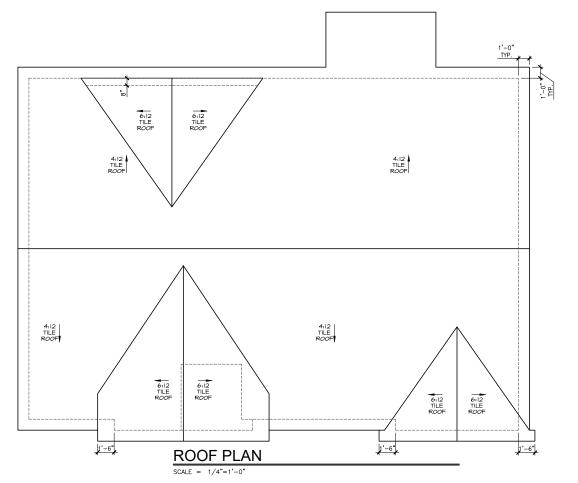
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ASH PROPERTIE NO O BUNGALOWS O Gilbert, Arizona CAVAN

PROJECT NO.: 10900a

CAD_FILE: 10900A-1355-A101 DRAWN RY: D.C.

CHECKED BY: D.C. SCALE: AS NOTED

3-BEDROOM FLOOR PLAN

Drawina No.: A1.1

3-BDRM SFH

FLOOR PLAN

ANNOR CLUBHOUSE

PLOOR PLAN

ANNOR CLUBHOUSE

PLOOR PLAN

ANNOR CLUBHOUSE


PLOOR PLAN

ANNOR CLUBHOUSE


PLOOR PLAN

ANNOR CLUBHOUSE

N O O R A D I A N	
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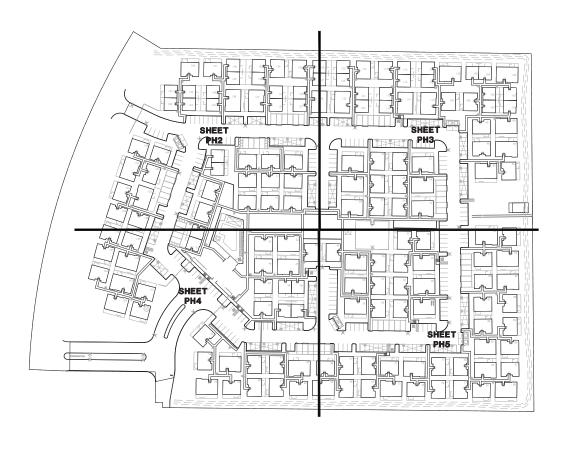


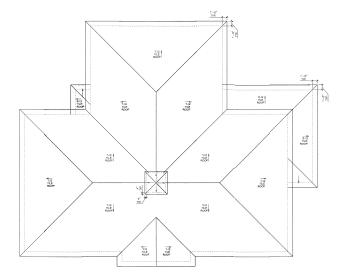
ROOF PLAN SOLE = 1/4"=1"-0"

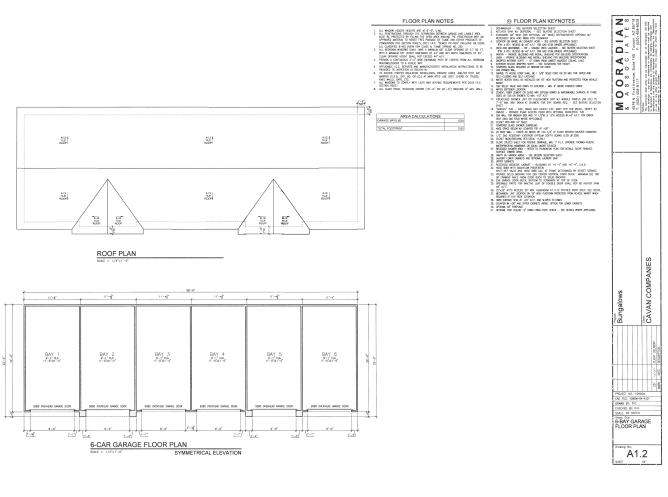

-/-/- OUENT DELMERY
AGAIN

THE BUNGALOWS ON ASH GILBERT RD & ASH ST PHOTOMETRIC LIGHTING PLAN



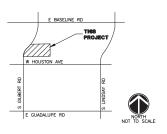


ELECTRICAL ENGINEER:
WRIGHT ENGINEERING CORPORATION
165 EAST CHLITON DRIVE
CHANDLER, AZ 65225
PHONE: (480) 497–5829
FAX: (480) 497–5807
CONTACT: AGCOB BIELEFELDT
EMAIL: JBIELEFELDT@WRIGHTENGINEERING.US

SHEET INDEX

SHEET PH1 — PHOTOMETRIC SITE PLAN SHEET PH2 — PHOTOMETRIC CALCULATIC SHEET PH3 — PHOTOMETRIC CALCULATIC SHEET PH4 — PHOTOMETRIC CALCULATIC SHEET PH5 — PHOTOMETRIC CALCULATIC





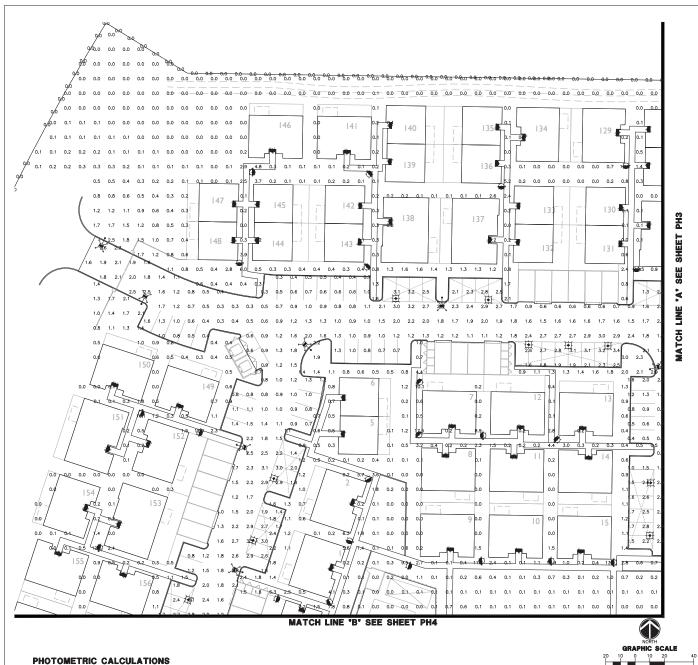

LEGEND

VISIONAIRE LIGHTING
PREMER BOLLARD

PREMER BOLLARD

I lamp(c) per luminoires photometry is absolute
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mounting heighte - 32. H., wetts per luminoire = 22
number locations - 74, number luminoires - 74
kw dil locations - 16

ESTIN - McGRAW-EDGON (YGAMER COPPER LIGHTING) CNC-E01-LED-E1-SQ - Condes The CNC-E01-LID-E1-SC Spec - Li lamp(a) per luminaire, photometry is obsolute Light Loss Foctor = 6000, wetts per luminaire = 25 number locations = 1.1 k w oil (coctions = 1.1)

UGFTWY NUUSTRES - PLUORESCENT WALL MOUNT LUMINARE — JASSON, EMBERC N.W. 27. LUMEN RATING = 1800 LMS. cardiely (Fw. N.W.M.S. 5 to 100 intid lumens per lamp to 100 per luminal to 10, watts per luminaire = 30 mounting height = 18 to, watts per luminaire = 30 mounting height = 18 to, number luminaires = 165 kw all locations = 5.0

CALCULATIONS

DRIVE AISLE & PARKING
1226 points at z=0, sp 10rt by 10rt
HORIZONTAL FOOTONDLES
Average 1.2
Average 1.2
Average 1.2
Avg.Min 8.26
Max.Min 3.4,50
Coef Var 0.52
Unifford 17.2.5

OPEN SPACE 2832 points at z=0, sp 10ft by 10ft HORIZONTAL FOOTCANDLES Average 0.7 Average 0.7 Average 0.0 Avgalfin N/A Avgalfin N/A Avgalfin N/A Coef Var 2,63 Uniford N/A

PROPERTY LINE

340 points

HORIZONTAL FOOTCANDLES

Average 0.1

Maximum 1.5

Minimum 0.0

Avg:Min N/A

Max:Min N/A


Coef Var 3.95







DESIGN BY: TDP

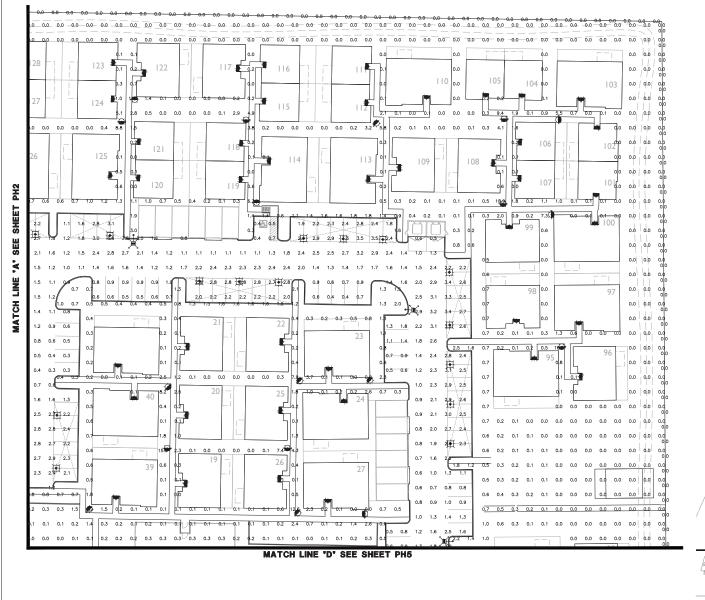

LEGEND

- SOURCE LIGHTING
 PREMIER BOLLARD
 PREMIER BOLLARD
 Indiging the PREMI-15W_2OLC_3_3KIES'
 1 lomp(s) per luminoire, photometry is obsolute
 to produce the produce of the produce
- EATON M-SORM-EDISON (FORMER COPER LIGHTING) CNC-E01-LED-E1-SQ 1-1 condeal file ("CMC-E01-LED-E1-SQ) isobolute 1-1 lamp(a) per luminaire, photometry is obsolute Light Loss Foctor = (3.00), watts per luminaire = 25 number | Socioloss = 1.1 kw all locotions = 1.1
- Ultronic Lighting DSX1 LED P2 30K TSW MVQLT

 State of the Control - LIGHTWAY INDUSTRIES FLUORESCENT WALL MOUNT LUMINAIRE MUSSING STRESS WILL SUMEN RATING = 1800 LMS: condeils file "VAWW.KS." 1800 Initial luminaire per lomp condeils file "VAWW.KS." 1800 Initial luminaire per lomp condeils file "VAWW.KS." 1800 Initial luminaire per luminoire = 30 munitary locations = 161, number locations = 165, number luminoires = 165 ke all locations = 5,0 number luminoires = 165

CALCULATIONS

DRIVE AISLE & PARKINO
1226 points at z=0, sp 10ft by 10ft
HORIZONTAL FOOTCAMDLES
Average
1.7
Average
1.7
Avg-Min
8.26
MoscMin
8.34.50
Coef Var
0.52
Unifford
17.25

OPEN SPACE 2832 points at z=0, sp 10ft by 10ft HONZONTAL FOOTCANDLES Average 0.2 points at z=0. Sp 10ft by 10ft HONZONTAL FOOTCANDLES Average 0.2 points at z=0. Sp 10ft by 10

PROPERTY LINE PROPERTY LINE
340 points
HORIZONTAL FOOTCANDLES
Average 0.1.1
Maximum 1.5
Minimum 0.0
Avg:Min N/A
Max:Min N/A
Coef Var 3.95










PHOTOMETRIC CALCULATIONS



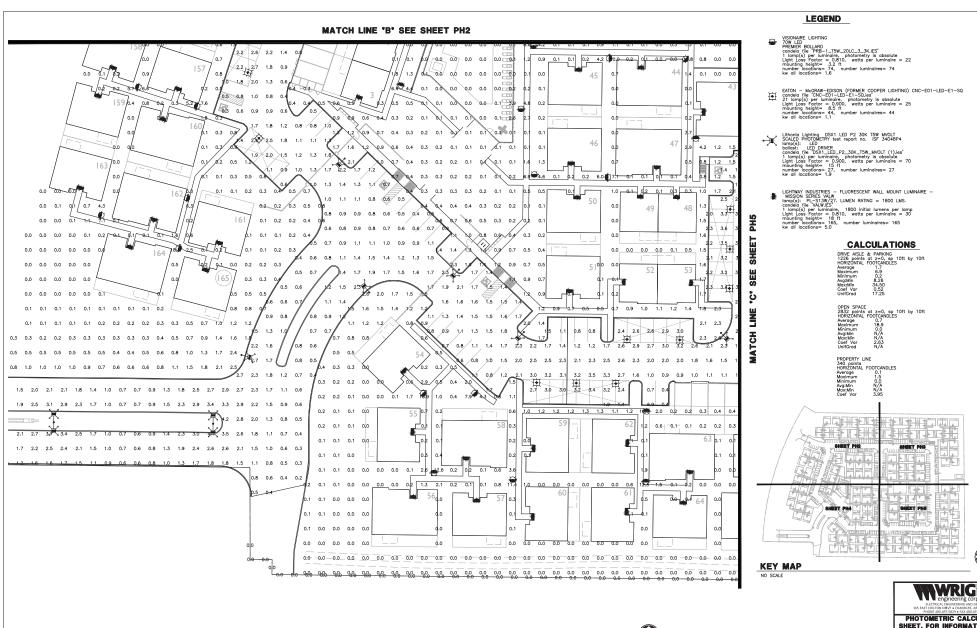

PHOTOMETRIC CALCULATION
NORTH

GRAPHIC SCALE

0 0 10 20 40


1 INCH = 20 FEET

DESIGN BY: The PHALE

RESIDENCE OF THE PHALE

RE

PHOTOMETRIC CALCULATIONS

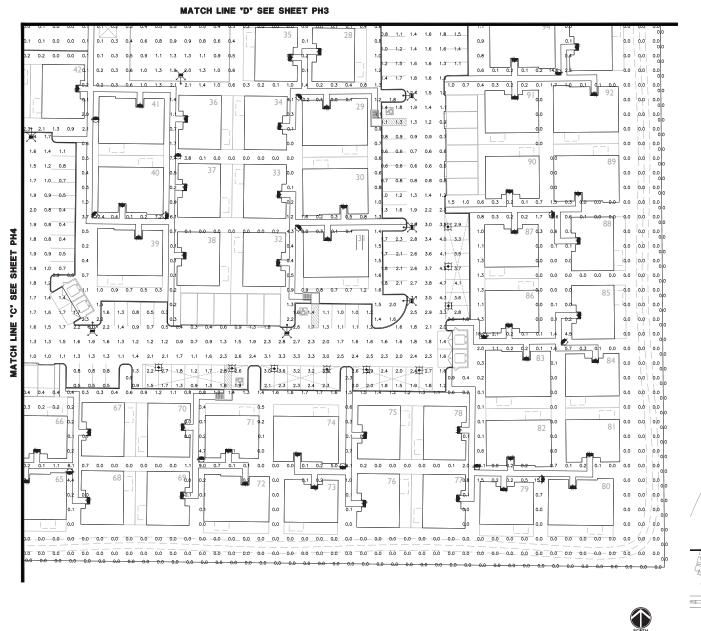

LEGEND

VISIONARE LIGHTING
TOTAL ED BOLLARD
CONSIDER OF THE PROPERTY O

ENTON - Medicine-Endody (Footers cooper Lighting) CNC-E01-LED-E1-SQ and Confided file (SNC-E01-LED-E1-SQ) and Confided file (SNC-E01-LED-E1-SQ) and Confided file (SNC-E01-LED-E1-SQ) and Confided file (SNC-E01-SQ) and

Lithonio Lighting DSX1 LED P2 30K TSW MVOLT CONTROL PROTECTION TO THE STREET REPORT TO THE ST

LIGHTWAY INDUSTRIES — FLUORESCENT WALL MOUNT LUMINAIRE — MISSON SERIES WIN ...

MISSON SERIES WIN ...

Condeid, file "VALMIES", LUMEN RATING = 1800 LMS. condeid, file "VALMIES", 1 lomp(s) per luminoire, 1800 initial lumens per lomp Light Loss Teacher "O.810", wotto per luminoire = 30 number locations = 165, number luminoires = 165 kr oil locations = 5.0

CALCULATIONS

DRIVE AISLE & PARKING
1226 points at z=0, sp 10ft by 10ft
HORIZONTAL FOOTCAMDLES
Average
1.7
Average
1.7
Avg.Min
Minimum
0.2
Avg.Min
8.26
Max.tkin
Cosf Var
0.52
17.25

OPEN SPACE 2832 points at z=0, sp 10ft by 10ft HORIZONTAL FOOTCANDLES 0.4 Average 18.9 Maximum 0.0 Avg.Nin N/A Max.Nin N/A Max.Nin N/A

PROPERTY LINE
340 points
HORIZONTAL FOOTCANDLES
Average 0.1
Moximum 1.5
Minimum 0.0
Avg:Min N/A
Mox:Min N/A
Coef Var 3.95



GRAPHIC SCALE


KEY MAP






DESIGN BY:

PHOTOMETRIC CALCULATIONS

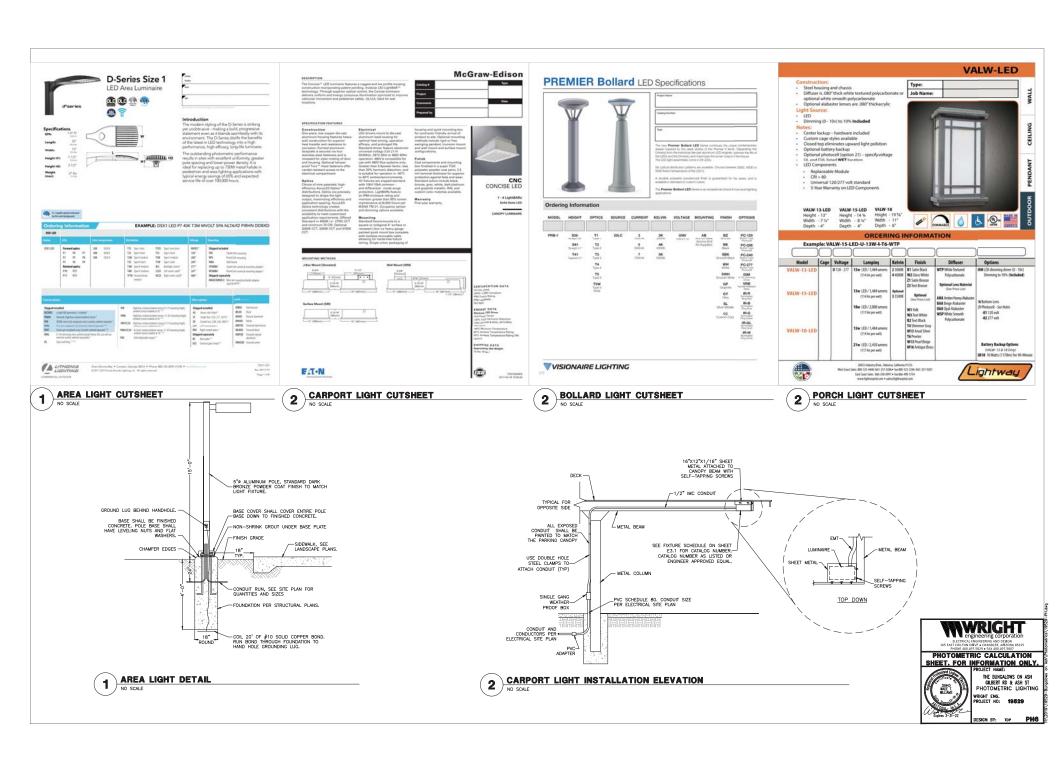

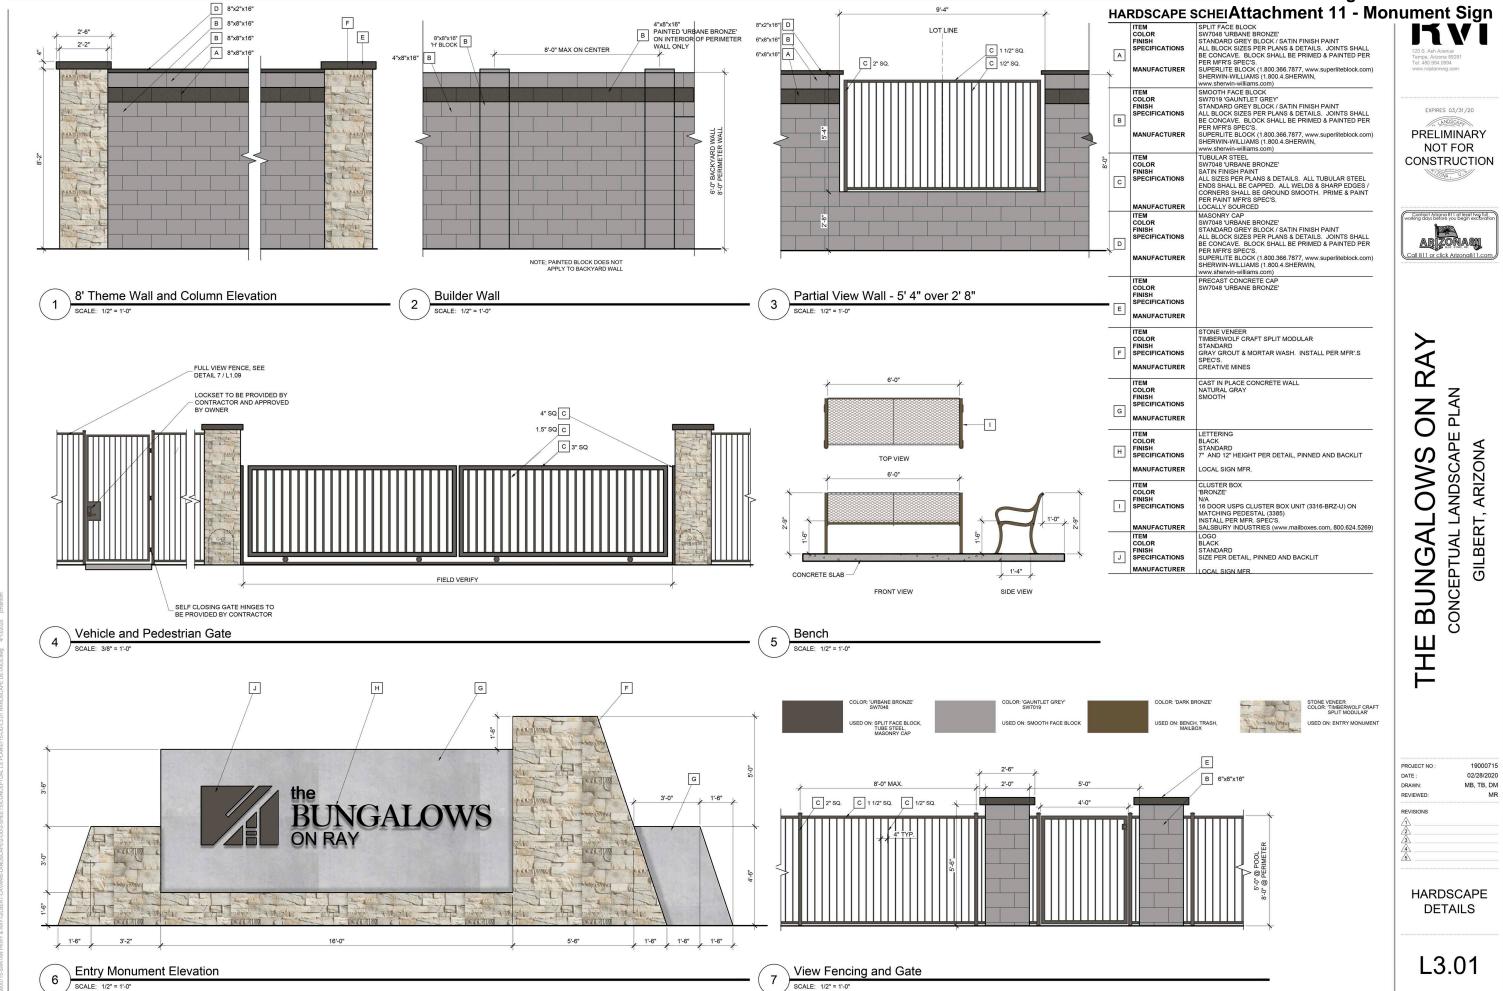

DR19-143 Bungalows on Ash

SHEET 7 OF 8